
1" RGS STUBBED UP 24" ABOVE

GRADE NEXT TO EXISTING POLE
BASE FOR FUTURE SURVEILLANCE
CAMERAS. CAP CONDUIT.

ANCHOR CONDUIT TO EXISTING POLE BASE. TYPICAL (TYP.)

FINISHED PAVING GRADE

SCALE: NTS

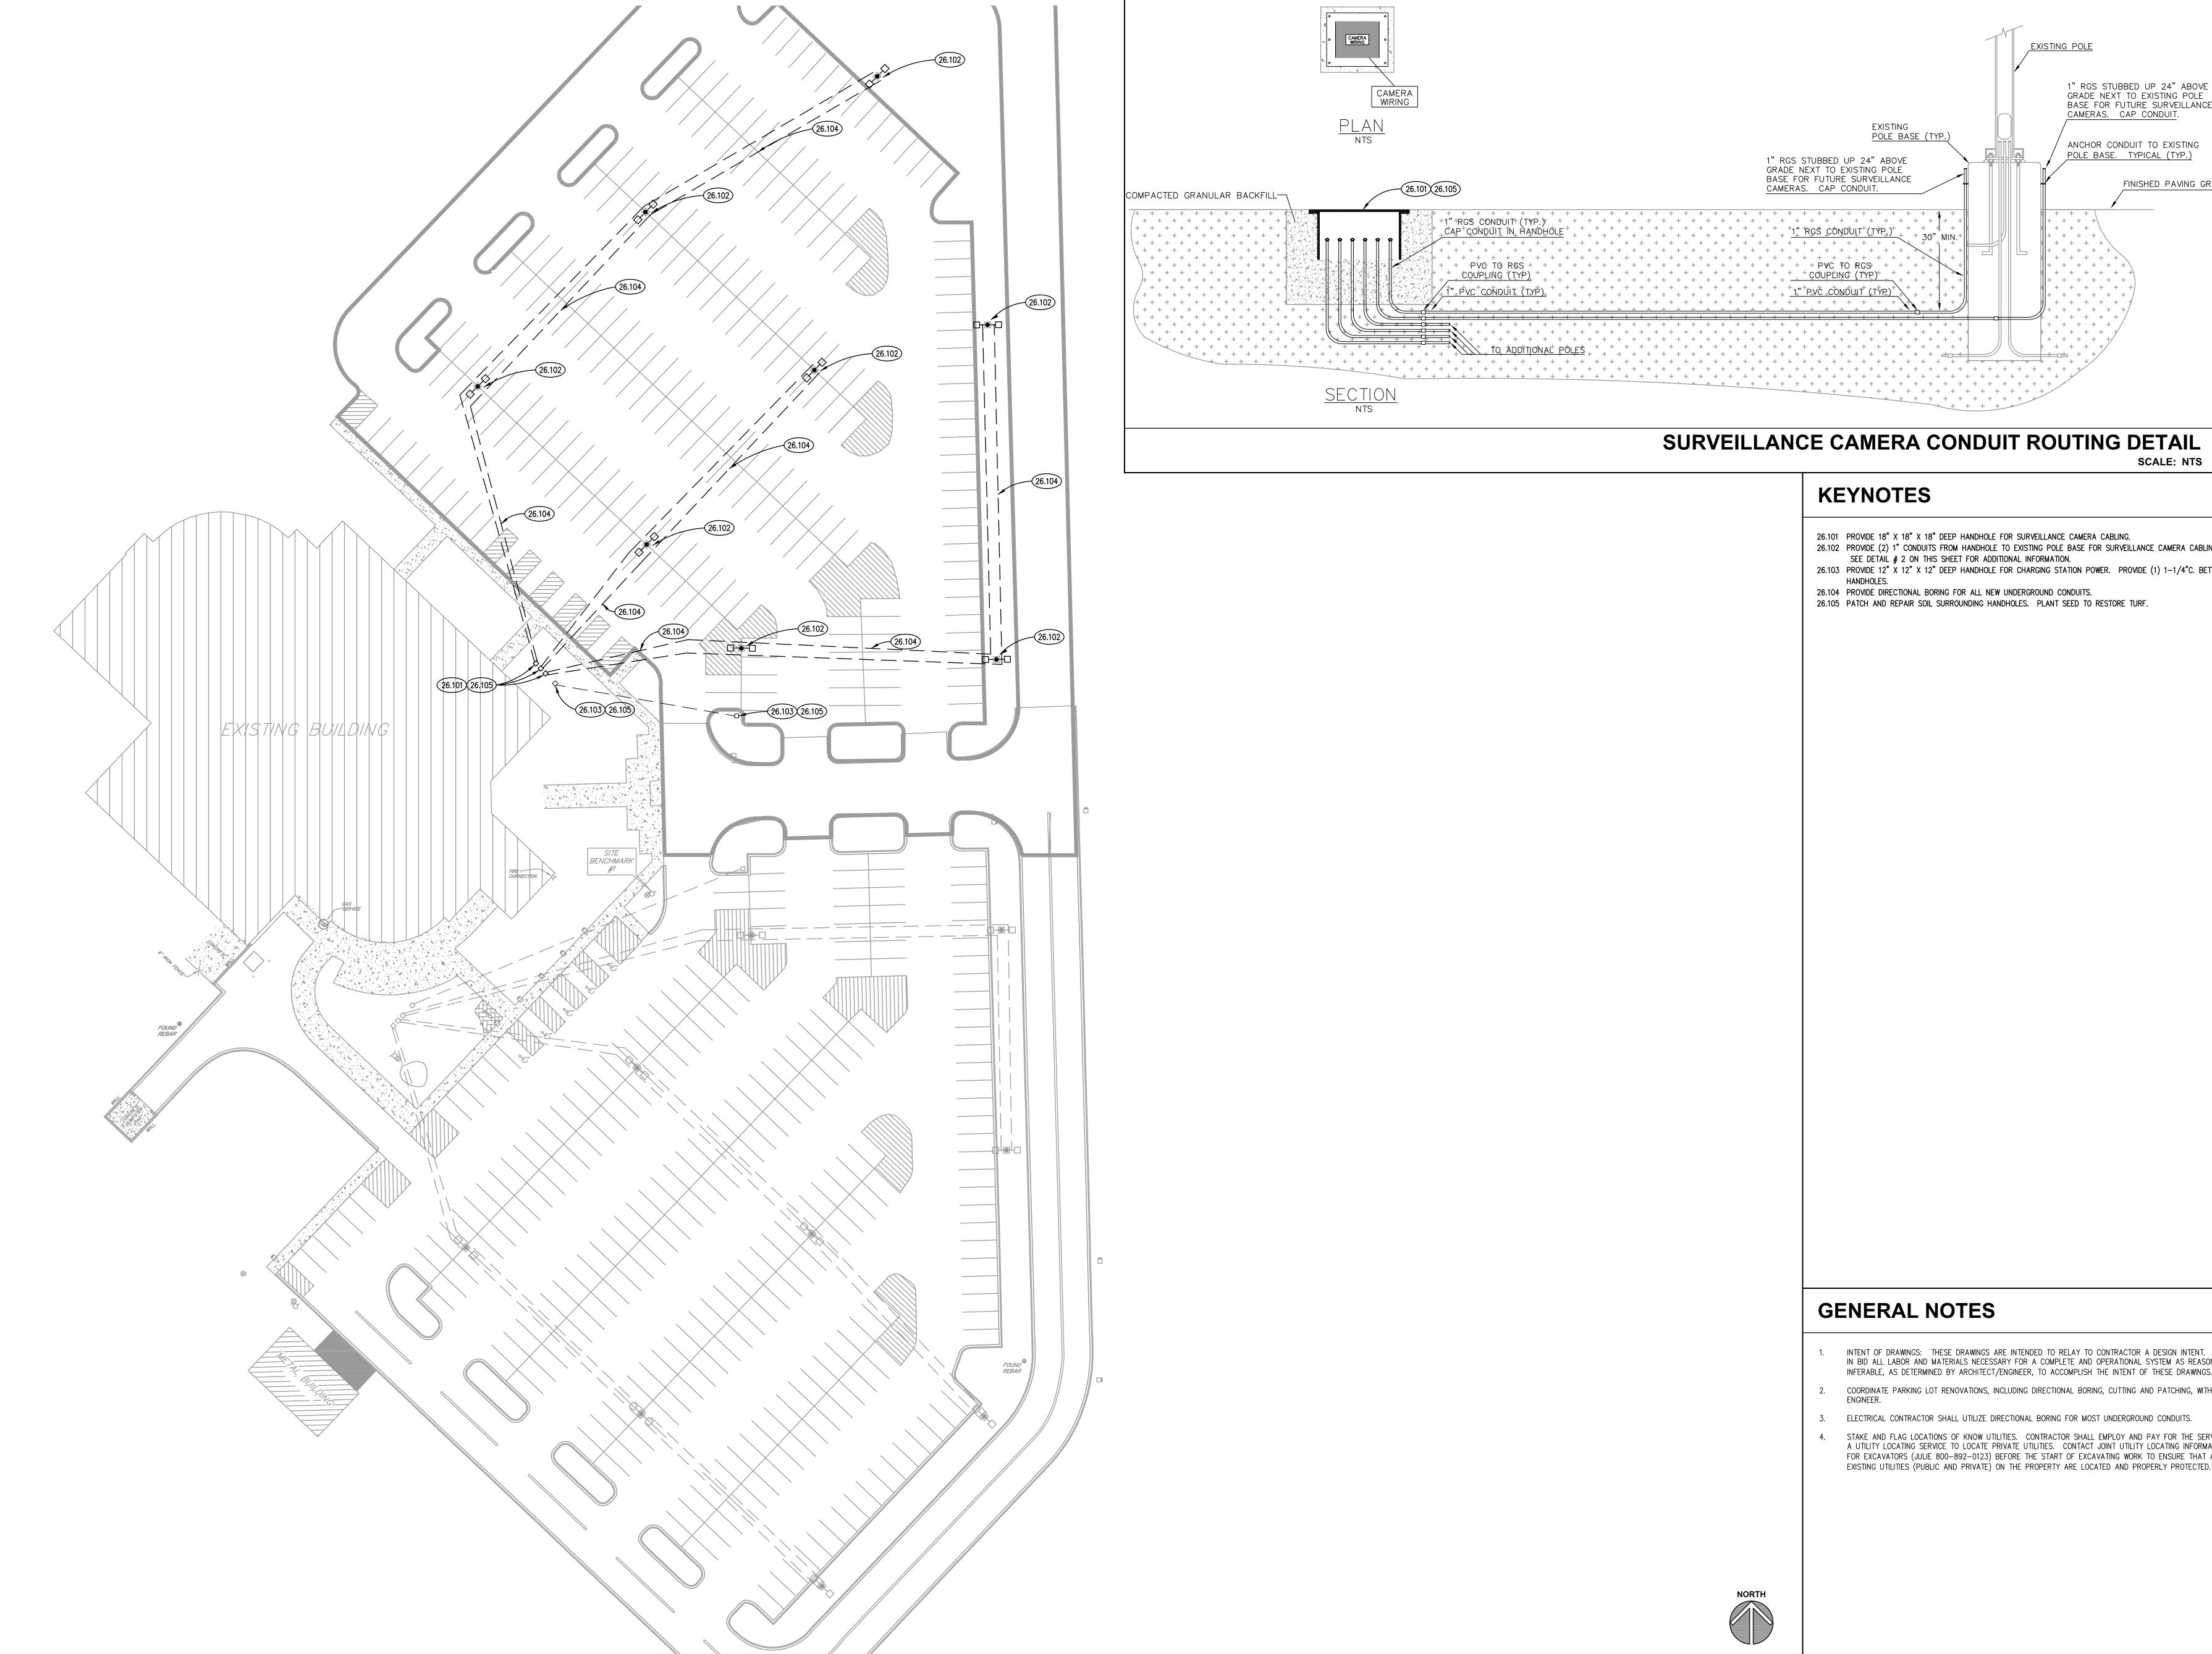

26.101 PROVIDE 18" X 18" X 18" DEEP HANDHOLE FOR SURVEILLANCE CAMERA CABLING. 26.102 PROVIDE (2) 1" CONDUITS FROM HANDHOLE TO EXISTING POLE BASE FOR SURVEILLANCE CAMERA CABLING.


SEE DETAIL # 2 ON THIS SHEET FOR ADDITIONAL INFORMATION. 26.103 PROVIDE 12" X 12" X 12" DEEP HANDHOLE FOR CHARGING STATION POWER. PROVIDE (1) 1-1/4"C. BETWEEN

26.104 PROVIDE DIRECTIONAL BORING FOR ALL NEW UNDERGROUND CONDUITS.

26.105 PATCH AND REPAIR SOIL SURROUNDING HANDHOLES. PLANT SEED TO RESTORE TURF.

INTENT OF DRAWINGS: THESE DRAWINGS ARE INTENDED TO RELAY TO CONTRACTOR A DESIGN INTENT. INCLUDE IN BID ALL LABOR AND MATERIALS NECESSARY FOR A COMPLETE AND OPERATIONAL SYSTEM AS REASONABLY INFERABLE, AS DETERMINED BY ARCHITECT/ENGINEER, TO ACCOMPLISH THE INTENT OF THESE DRAWINGS.

- 4. STAKE AND FLAG LOCATIONS OF KNOW UTILITIES. CONTRACTOR SHALL EMPLOY AND PAY FOR THE SERVICES OF A UTILITY LOCATING SERVICE TO LOCATE PRIVATE UTILITIES. CONTACT JOINT UTILITY LOCATING INFORMATION FOR EXCAVATORS (JULIE 800-892-0123) BEFORE THE START OF EXCAVATING WORK TO ENSURE THAT ALL EXISTING UTILITIES (PUBLIC AND PRIVATE) ON THE PROPERTY ARE LOCATED AND PROPERLY PROTECTED.

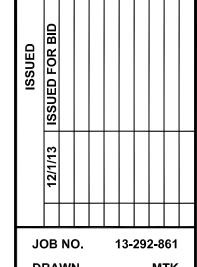

CHECKED **APPROVED**

SHEET TITLE **ELECTRICAL**


PLAN

SHEET NUMBER

ELECTRICAL SITE PLAN

SCALE: 1" = 30'-0"



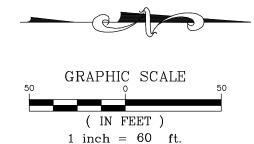

LEGEND

PROPOSED SOIL BORING LOCATION

TOTAL PROJECT AREA = 13,023.94 s.y.

	REVISIONS							
No.	DATE	DESCRIPTION	BY					
1	10-07-2013	AMENDED VIEW LIMITS	R.P.					
2	10-22-2013	AMENDED TITLE & CONTENTS	R.P.					
3	11-18-2013	AMENDED TITLE & CONTENTS	R.P.					

DOCUMENTATION:
PROJ. No.: 20121330.00
DATE: 01-16-2013
FIELD BOOK:
PAGE:
DRAWN BY: R.M.
CHECKED BY: J.H.



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129 CAPISTA DRIVE - SHOREWOOD, ILLINOIS 60404
PH. (815) 744-6600 FAX (815) 744-0101
website: www.ruettigertonelli.com

PREPARED FOR:


JOLIET JUNIOR COLLEGE 1215 HOUBOLT ROAD JOLIET, ILLINOIS 60431 DRAWING TITLE:


J.J.C. ROMEOVILLE CAMPUS PROJECT LIMITS DRAWING No.: 2012-1330-E01

SCALE: AS NOTED

SHEET 1 OF 1

E01-North Parking area Pavement Type.dwg, Layout1, 11/18/2013 11:14:29 AM, Rpeeples

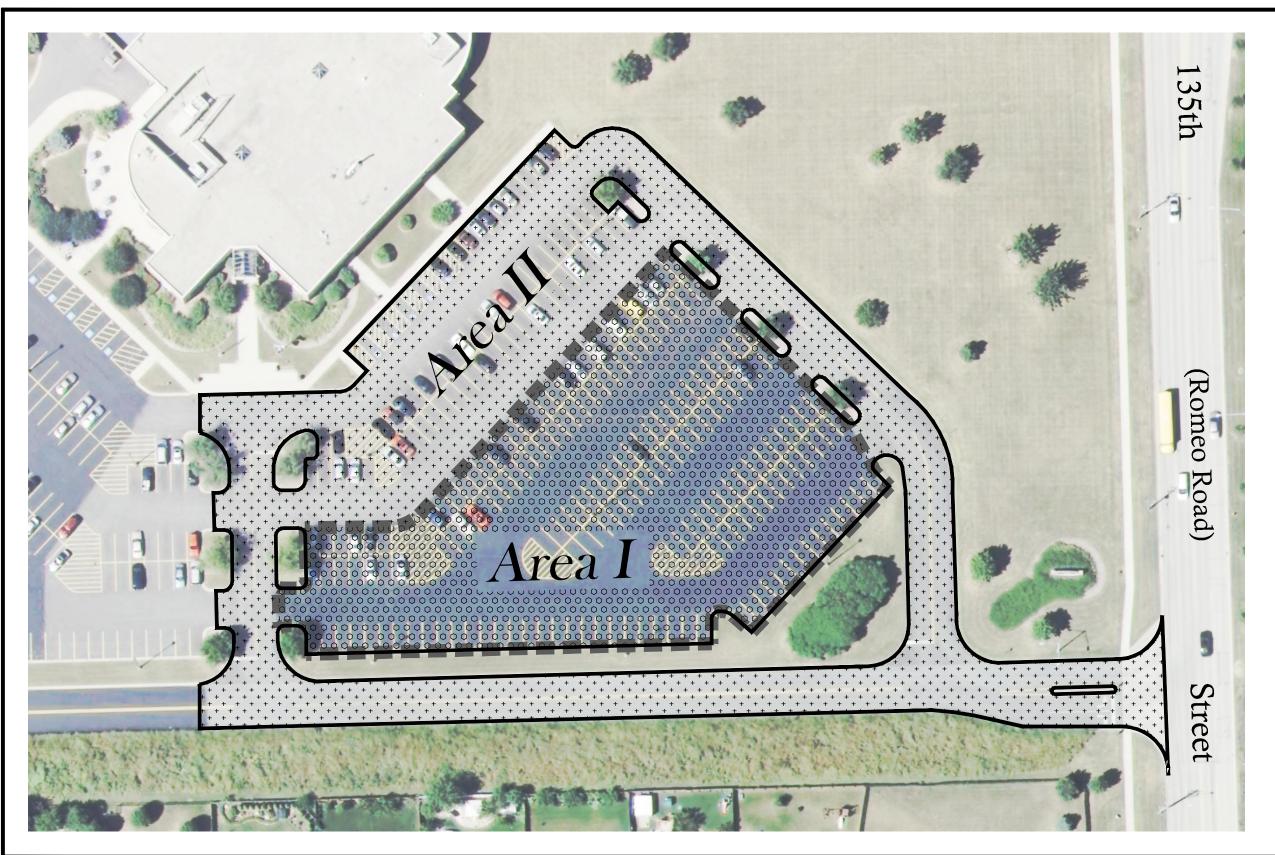

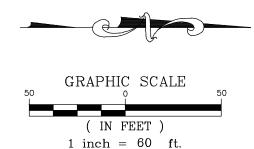

<u>EGEND</u>

Area I = 5,723 s.y.Reconstruction



Area II = 7,301 s.y. Grind and Overlay

	REVISIONS								
No.	DATE	DESCRIPTION	BY						
1	10-22-2013	AMENDED CONTENTS	R.P.						
2	11-18-2013	AMENDED CONTENTS	R.P.						
		·							

DOCUMENTATION: PROJ. No.: 20121330.00
DATE: 10-07-2013
FIELD BOOK:
PAGE:
DRAWN BY: R.P.
CHECKED BY: J.H.

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PREPARED FOR:

JOLIET JUNIOR COLLEGE **1215 HOUBOLT ROAD JOLIET, ILLINOIS 60431**

DRAWING TITLE:

J.J.C. ROMEOVILLE CAMPUS **PROPOSED CONSTRUCTION LIMITS NORTH PARKING AREA**

DRAWING No.: 2012-1330-E02

SCALE: AS NOTED


SHEET 1 OF 1

MC-30 PRIME COAT @ 0.35 GAL/SY

ALL EXISTING FILL AND BASE MATERIALS TO BE RE-USED MUST BE TESTED AND COMPACTED AS REQUIRED TO MEET MINIMUM REQUIREMENTS.

PROPOSED LIGHT DUTY PAVEMENT SECTION (AREA I AND TRENCH AREAS)

NOT TO SCALE

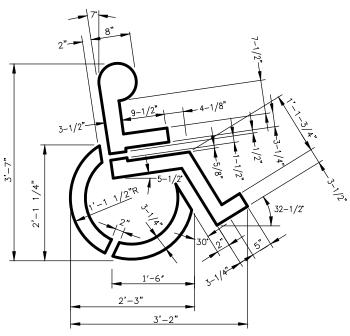

PAINT TO BE IDOT STD. WHITE OR THERMOPLASTIC EQUIVALENT

NOTE:

1.) A.D.A PARKING SYMBOL SHALL BE PAINTED ON A BLUE 4 FOOT WIDE BY 5 FOOT HIGH BOX.

A.D.A. PARKING SYMBOL

NOT TO SCALE

	h	REVISIONS	DOCUMENTATION:	
No.	DATE	DESCRIPTION	BY	PROJ. No.: 20121330.00
1	10-22-2013	AMENDED CONTENTS	R.P.	DATE: 10-07-2013
2	11-18-2013	AMENDED CONTENTS	R.P.	FIELD BOOK:
				PAGE:
				DRAWN BY: R.P.
				CHECKED BY: J.H.



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PREPARED FOR:

JOLIET JUNIOR COLLEGE **1215 HOUBOLT ROAD JOLIET, ILLINOIS 60431**

DRAWING TITLE: J.J.C. ROMEOVILLE CAMPUS A.D.A. PAVEMENT MARKINGS & TYPICAL PAVEMENT **CROSS-SECTIONS**

NORTH PARKING AREA

DRAWING No.: 2012-1330-E03

SCALE: **AS NOTED**

SHEET 1 OF 1


1-1/2" BITUMINOUS CONC. SURFACE COURSE EXISTING BITUMINOUS CONC. BINDER COURSE EXISTING COMPACTED BASE MC-30 TACK COAT-

@ 0.10 GAL/SY

CONTRACTOR SHALL GRIND/MILL 1.5" OF EXISTING BITUMINOUS PAVEMENT AND CONSTRUCT NEW 1.5" BITUMINOUS

PROPOSED PAVEMENT SECTION (AREA II)

NOT TO SCALE

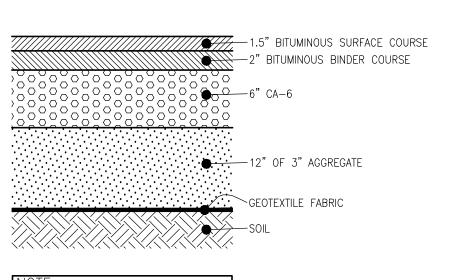

UNDERCUT PAVEMENT CROSS SECTION

ALL EXISTING FILL AND BASE MATERIALS

AND COMPACTED AS REQUIRED TO MEET

TO BE RE-USED MUST BE TESTED

MINIMUM REQUIREMENTS.

NOT TO SCALE

2.5"x2.5" PERFORATED TELESPAR GALVANIZED 12 GAGE POST (UNI-STRUT OR APPROVED EQUAL.) BOLTED ~ **FINISHED** GRADE 2.25"x2.25" PERFORATED TELESPAR GALVANIZED 12 GAGE POST (UNI-STRUT OR APPROVED EQUAL.) AUGER HOLE AND COMPACT LIMESTONE SCREENING CAPPED WITH P.C.C. TO MATCH EXISTING PAVEMENT


TYPICAL SIGN INSTALLATION

NOT TO SCALE

Improvement Plans for

JOLIEU JUNIOR COLLECE MAIN CAMPUS - REAR ACCESS DRIVE

City of Joliet Will County, Illinois

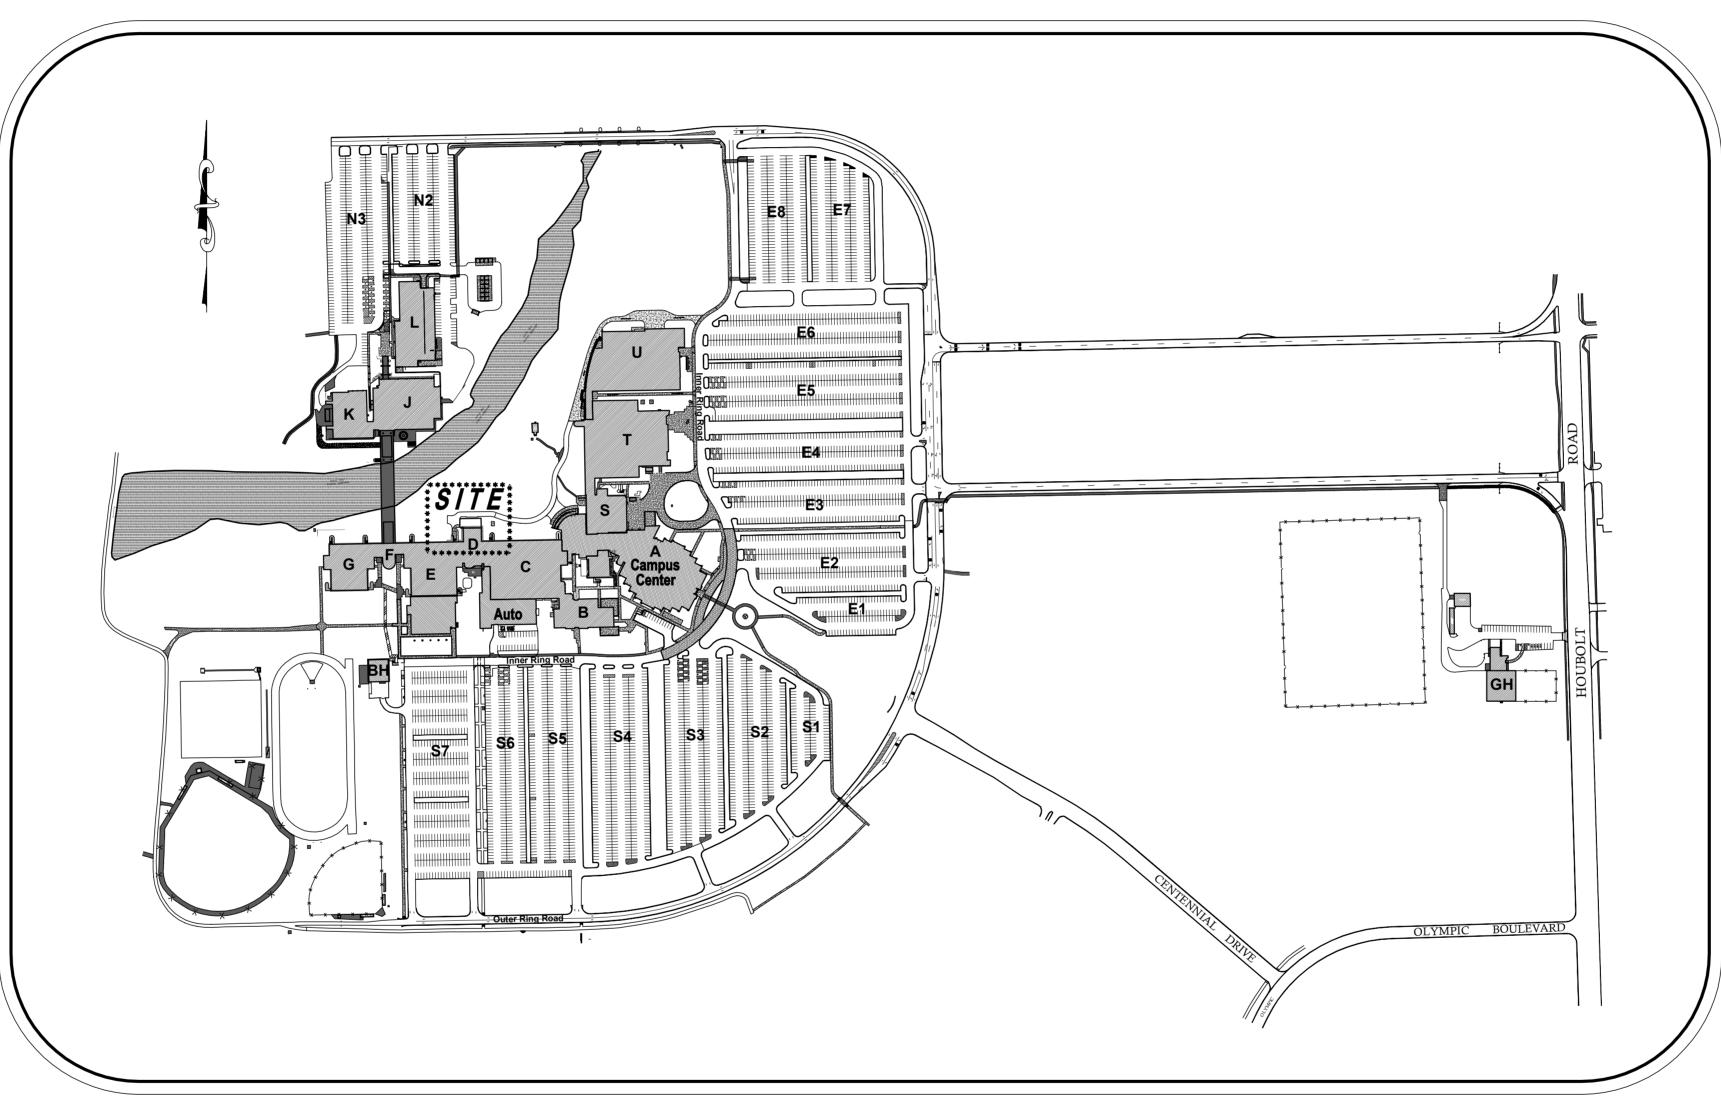

INDEX OF ENGINEERING SHEETS

DESCRIPTION

COVER SHEET

PROPOSED GEOMETRY PLAN

GENERAL NOTES AND CONSTRUCTION DETAILS

INDEX OF LANDSCAPING SHEETS

DESCRIPTION SHEET No.

LANDSCAPING PLAN

LANDSCAPING SPECIFICATIONS & DETAILS

SITE LOCATION MAP SCALE: 1" = 300'



LAND SURVEYOR / ENGINEER:

RUETTIGER, TONELLI & ASSOCIATES, INC. 129 CAPISTA DRIVE SHOREWOOD, ILLINOIS 60404 Ph. (815) 744-6600

OWNER / DEVELOPER:

JOLIET JUNIOR COLLEGE 1215 HOUBOLT ROAD JOLIET, ILLINOIS 60431 Ph. (815) 729-9020

SITE BENCHMARK 1: HEAD BOLT ON FIRE HYDRANT THAT ARROW POINTS TO, LOCATED APPROXIMATELY 740' SOUTH OF MAIN CAMPUS EXIT ROAD ONTO HOUBOLT ROAD ELEVATION: 607.75 (NAVD 88) SITE BENCHMARK 2: HEAD BOLT ON FIRE HYDRANT THAT ARROW POINTS TO, LOCATED APPROXIMATELY 305' SOUTH OF MAIN CAMPUS EXIT ROAD ONTO HOUBOLT ROAD. ELEVATION: 601.09 (NAVD 88) FIELD VERIFY BENCHMARK WITH BENCHMARK LIST.

R E V I S I O N S								DOCUMENTATION:
No.	DATE	DESCRIPTION	BY	No.	DATE	DESCRIPTION	BY	
1	11-18-2013	REVISED PER CLIENT REVIEW	R.P.					PROJECT No.: 20121330.00
2	12-09-2013	REVISED PER CLIENT REVIEW	R.P.					DATE: 10-08-2013
3	2-05-2014	REVISED PER JOLIET JUNIOR COLLEGE	R.P.					FIELD BOOK:
								DRAWN BY: R.P.



CHECKED BY: J.H.

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PROJECT TITLE:

JOLIET JUNIOR COLLEGE MAIN CAMPUS - REAR ACCESS DRIVE 1215 HOUBOLT ROAD JOLIET, ILLINOIS 60431


DRAWING TITLE:

COVER SHEET

DRAWING No. 312-1330-C2 SCALE:

ENGINEERING DEPARTMENT

AS NOTED SHEET 1 OF 5

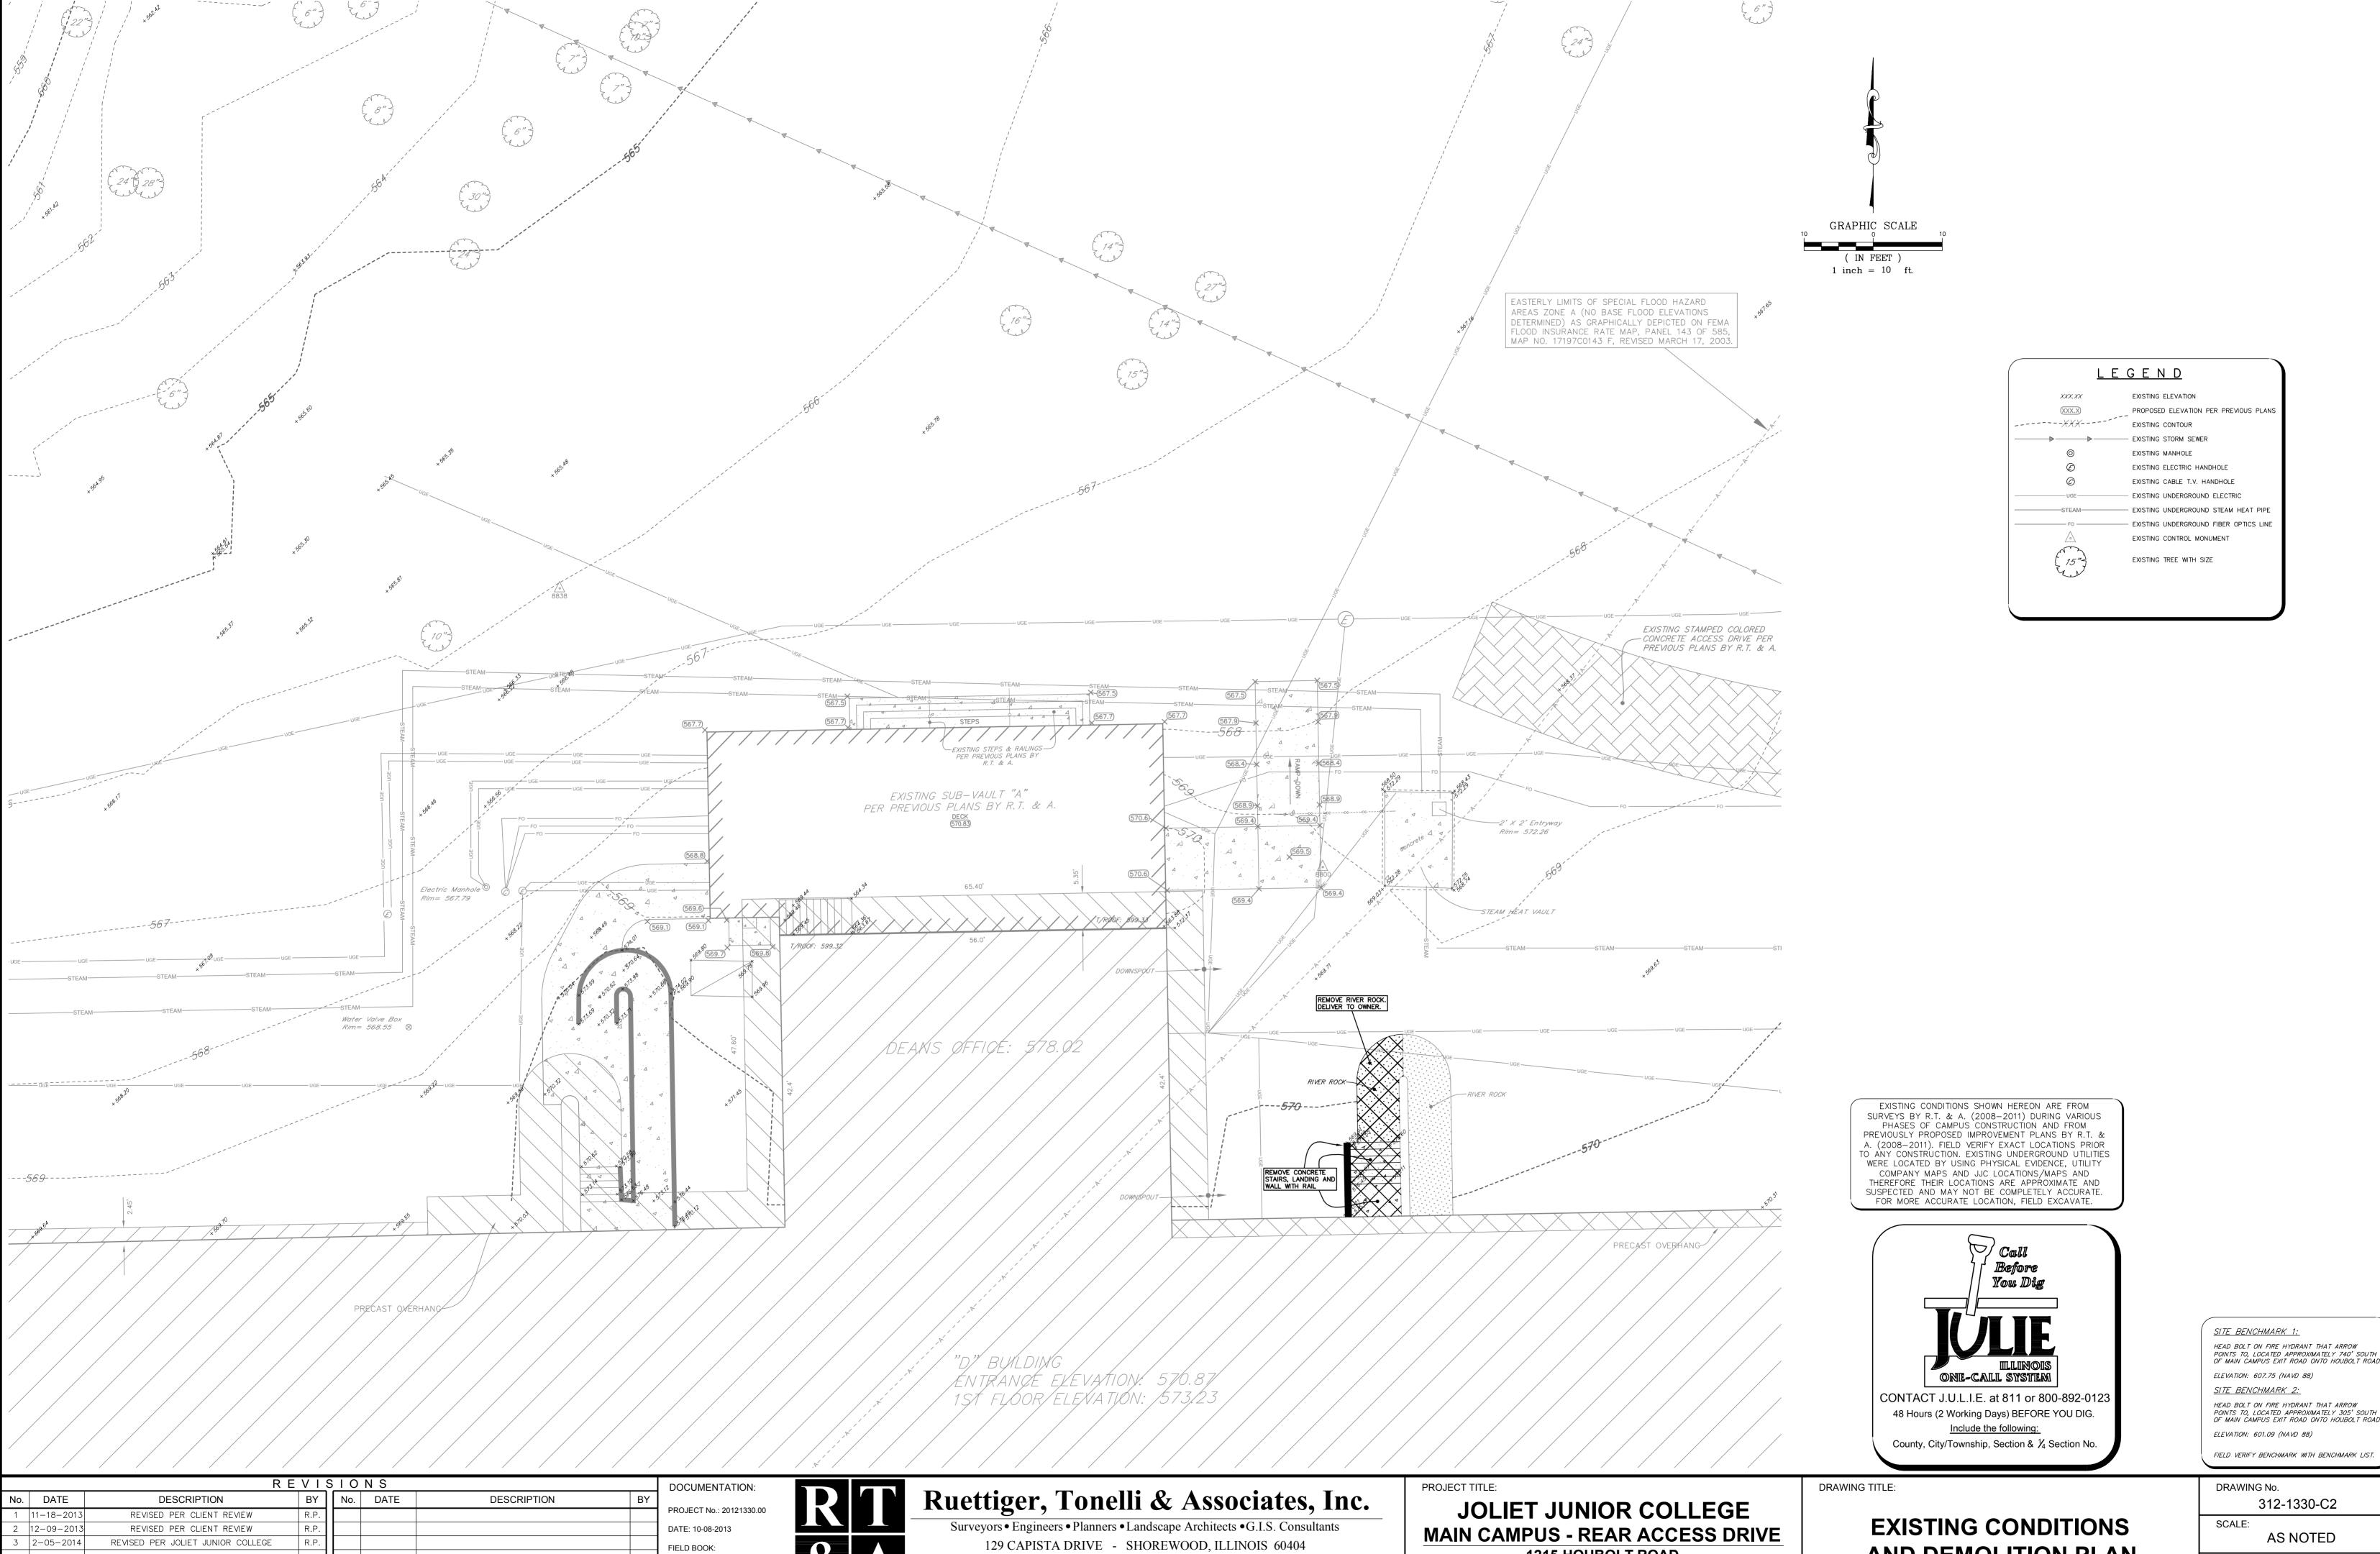

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website: www.ruettigertonelli.com

FIELD BOOK:

DRAWN BY: R.P.

CHECKED BY: J.H.

312-1330-C2


AS NOTED ENGINEERING DEPARTMENT

SHEET 2 OF 5

AND DEMOLITION PLAN

1215 HOUBOLT ROAD

JOLIET, ILLINOIS 60431

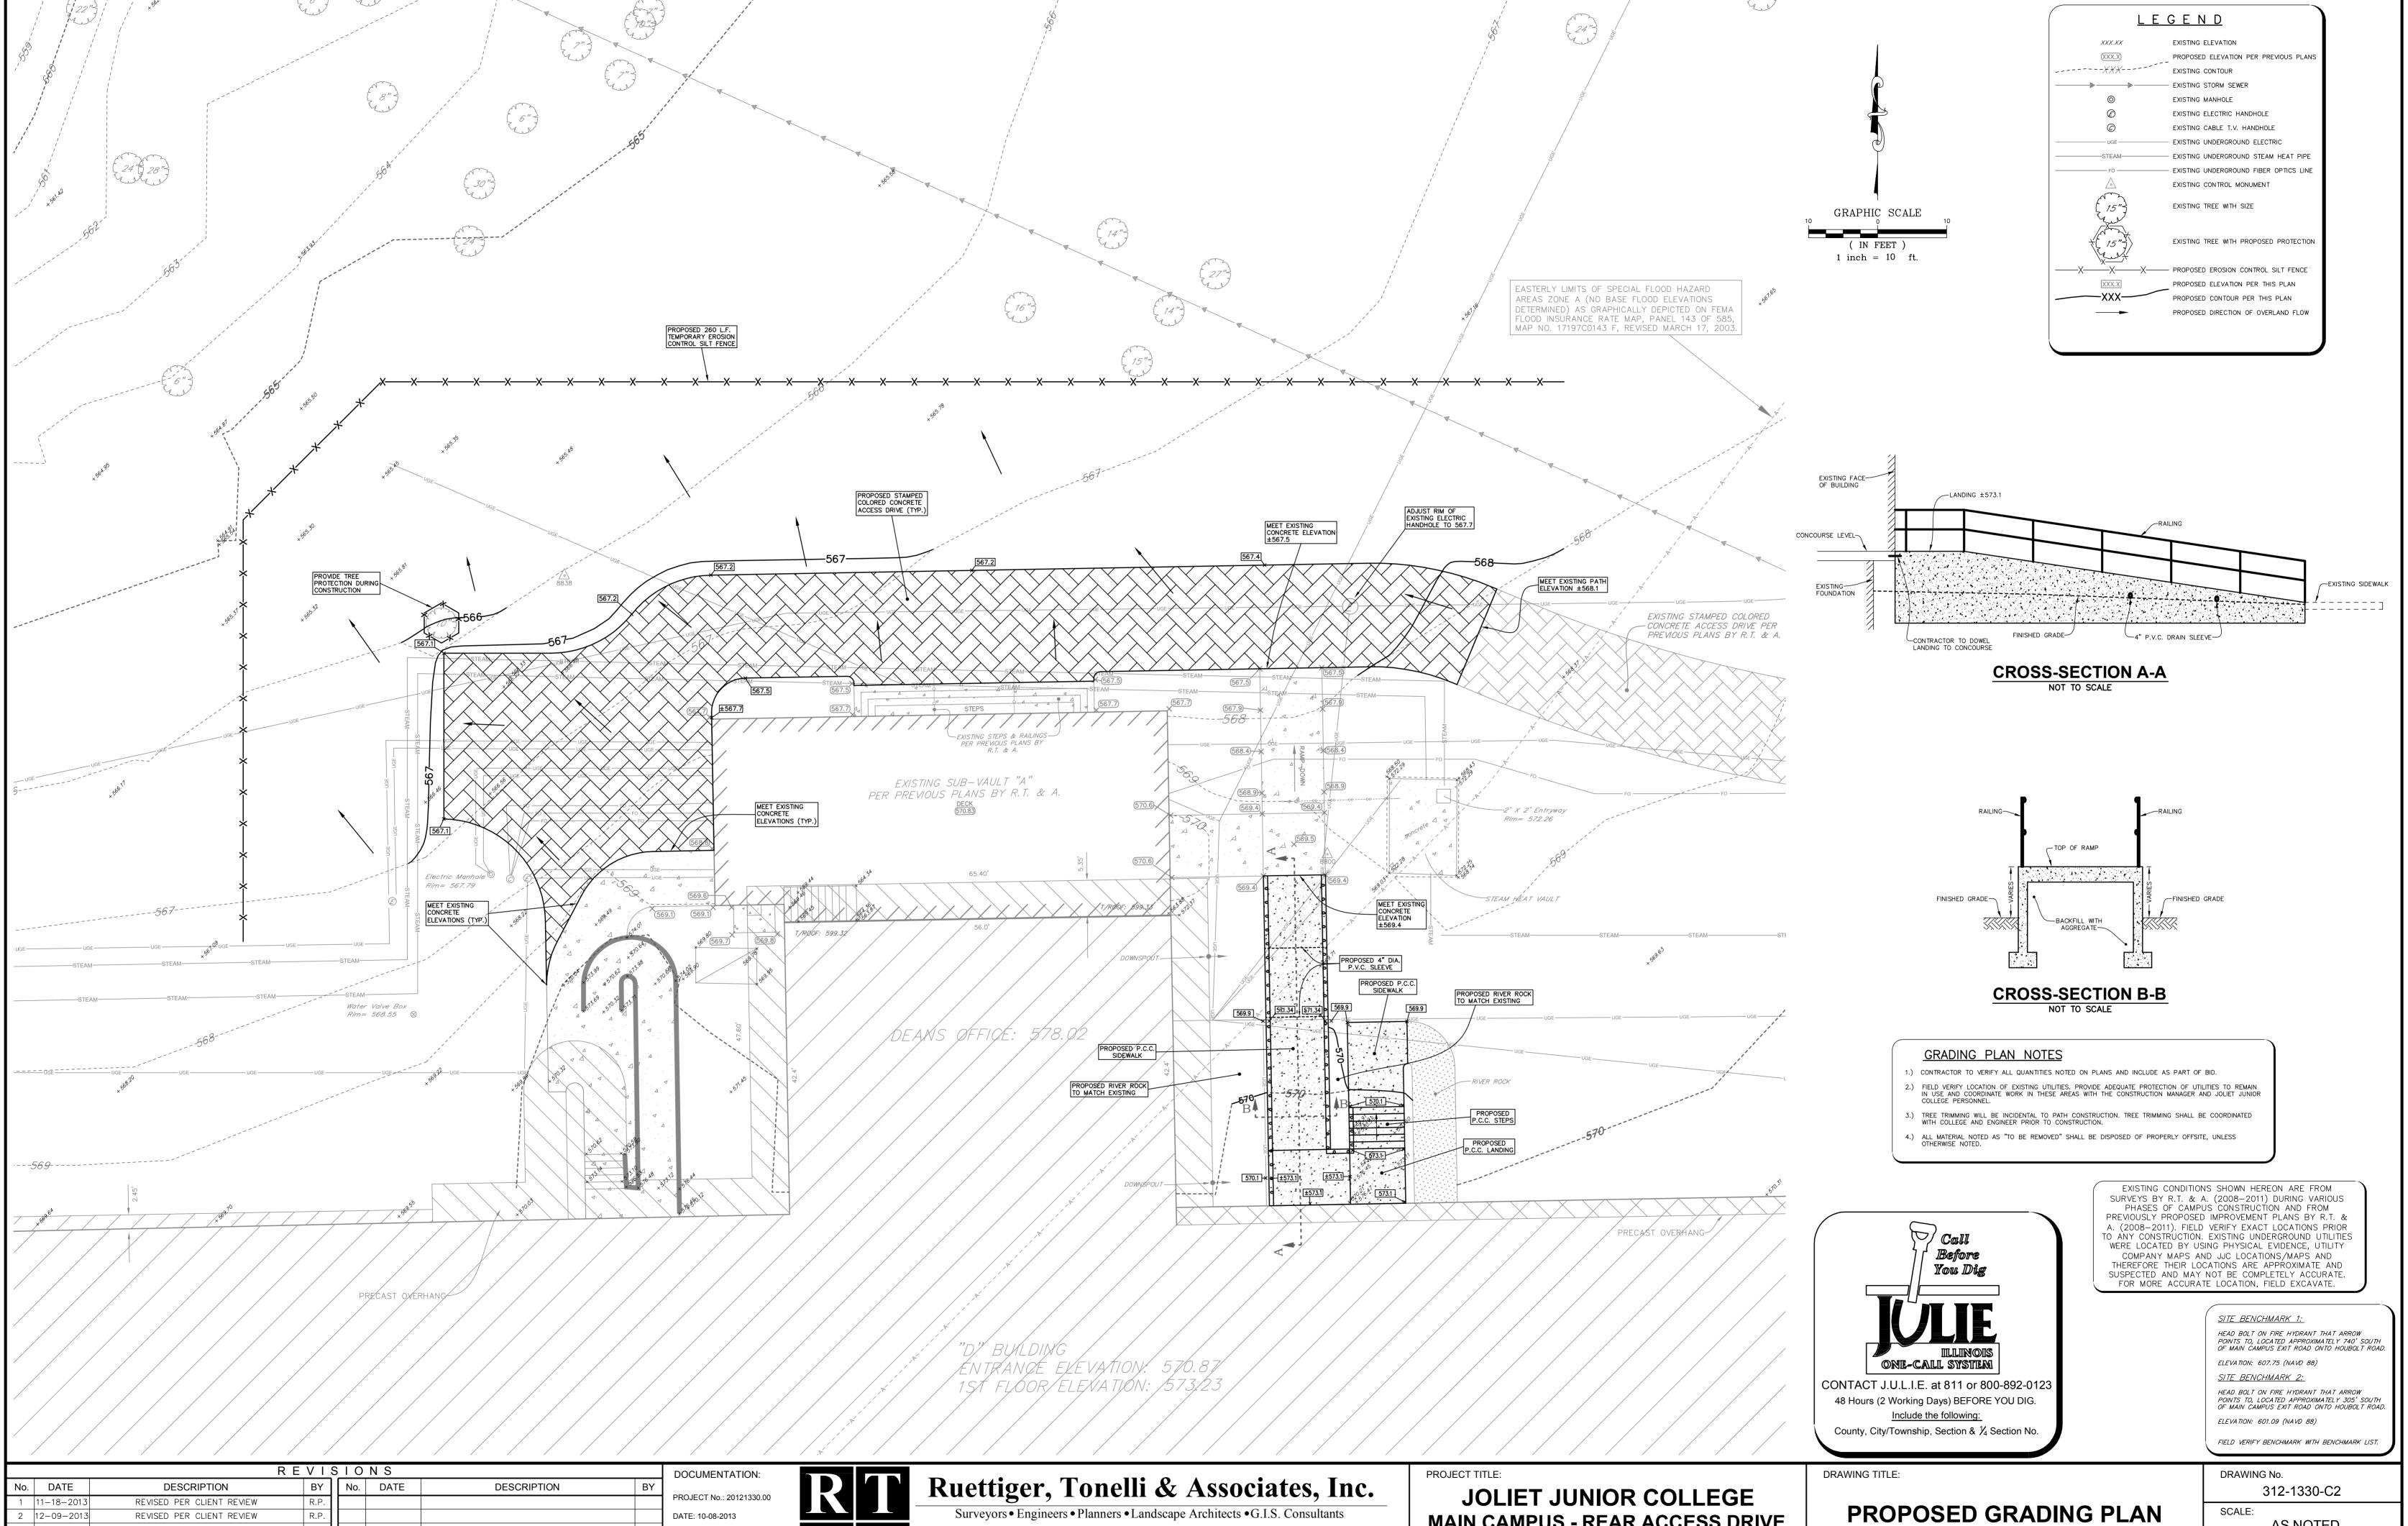

129 CAPISTA DRIVE - SHOREWOOD, ILLINOIS 60404

website: www.ruettigertonelli.com

PH. (815) 744-6600 FAX (815) 744-0101

MAIN CAMPUS - REAR ACCESS DRIVE

1215 HOUBOLT ROAD

JOLIET, ILLINOIS 60431

REVISED PER CLIENT REVIEW

REVISED PER JOLIET JUNIOR COLLEGE

DATE: 10-08-2013

FIELD BOOK:

DRAWN BY: R.P.

CHECKED BY: J.H.


2 | 12-09-2013


3 2-05-2014

AS NOTED

ENGINEERING DEPARTMENT SHEET 3 OF 5

AND EROSION CONTROL PLAN

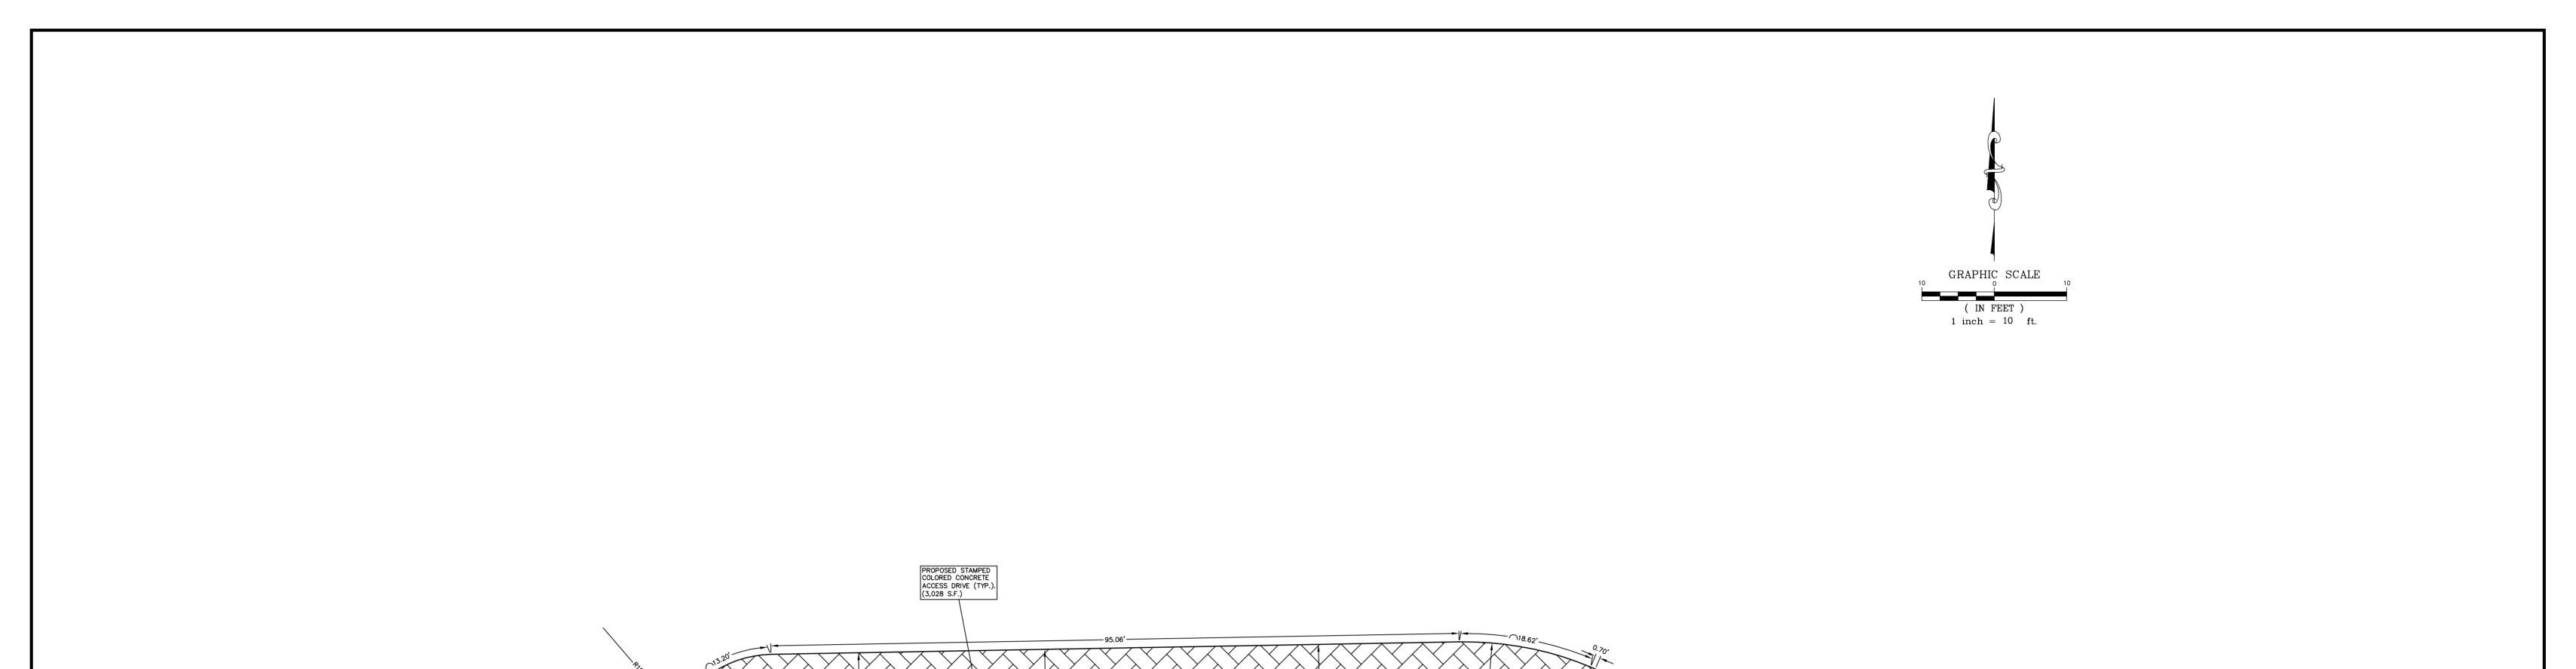

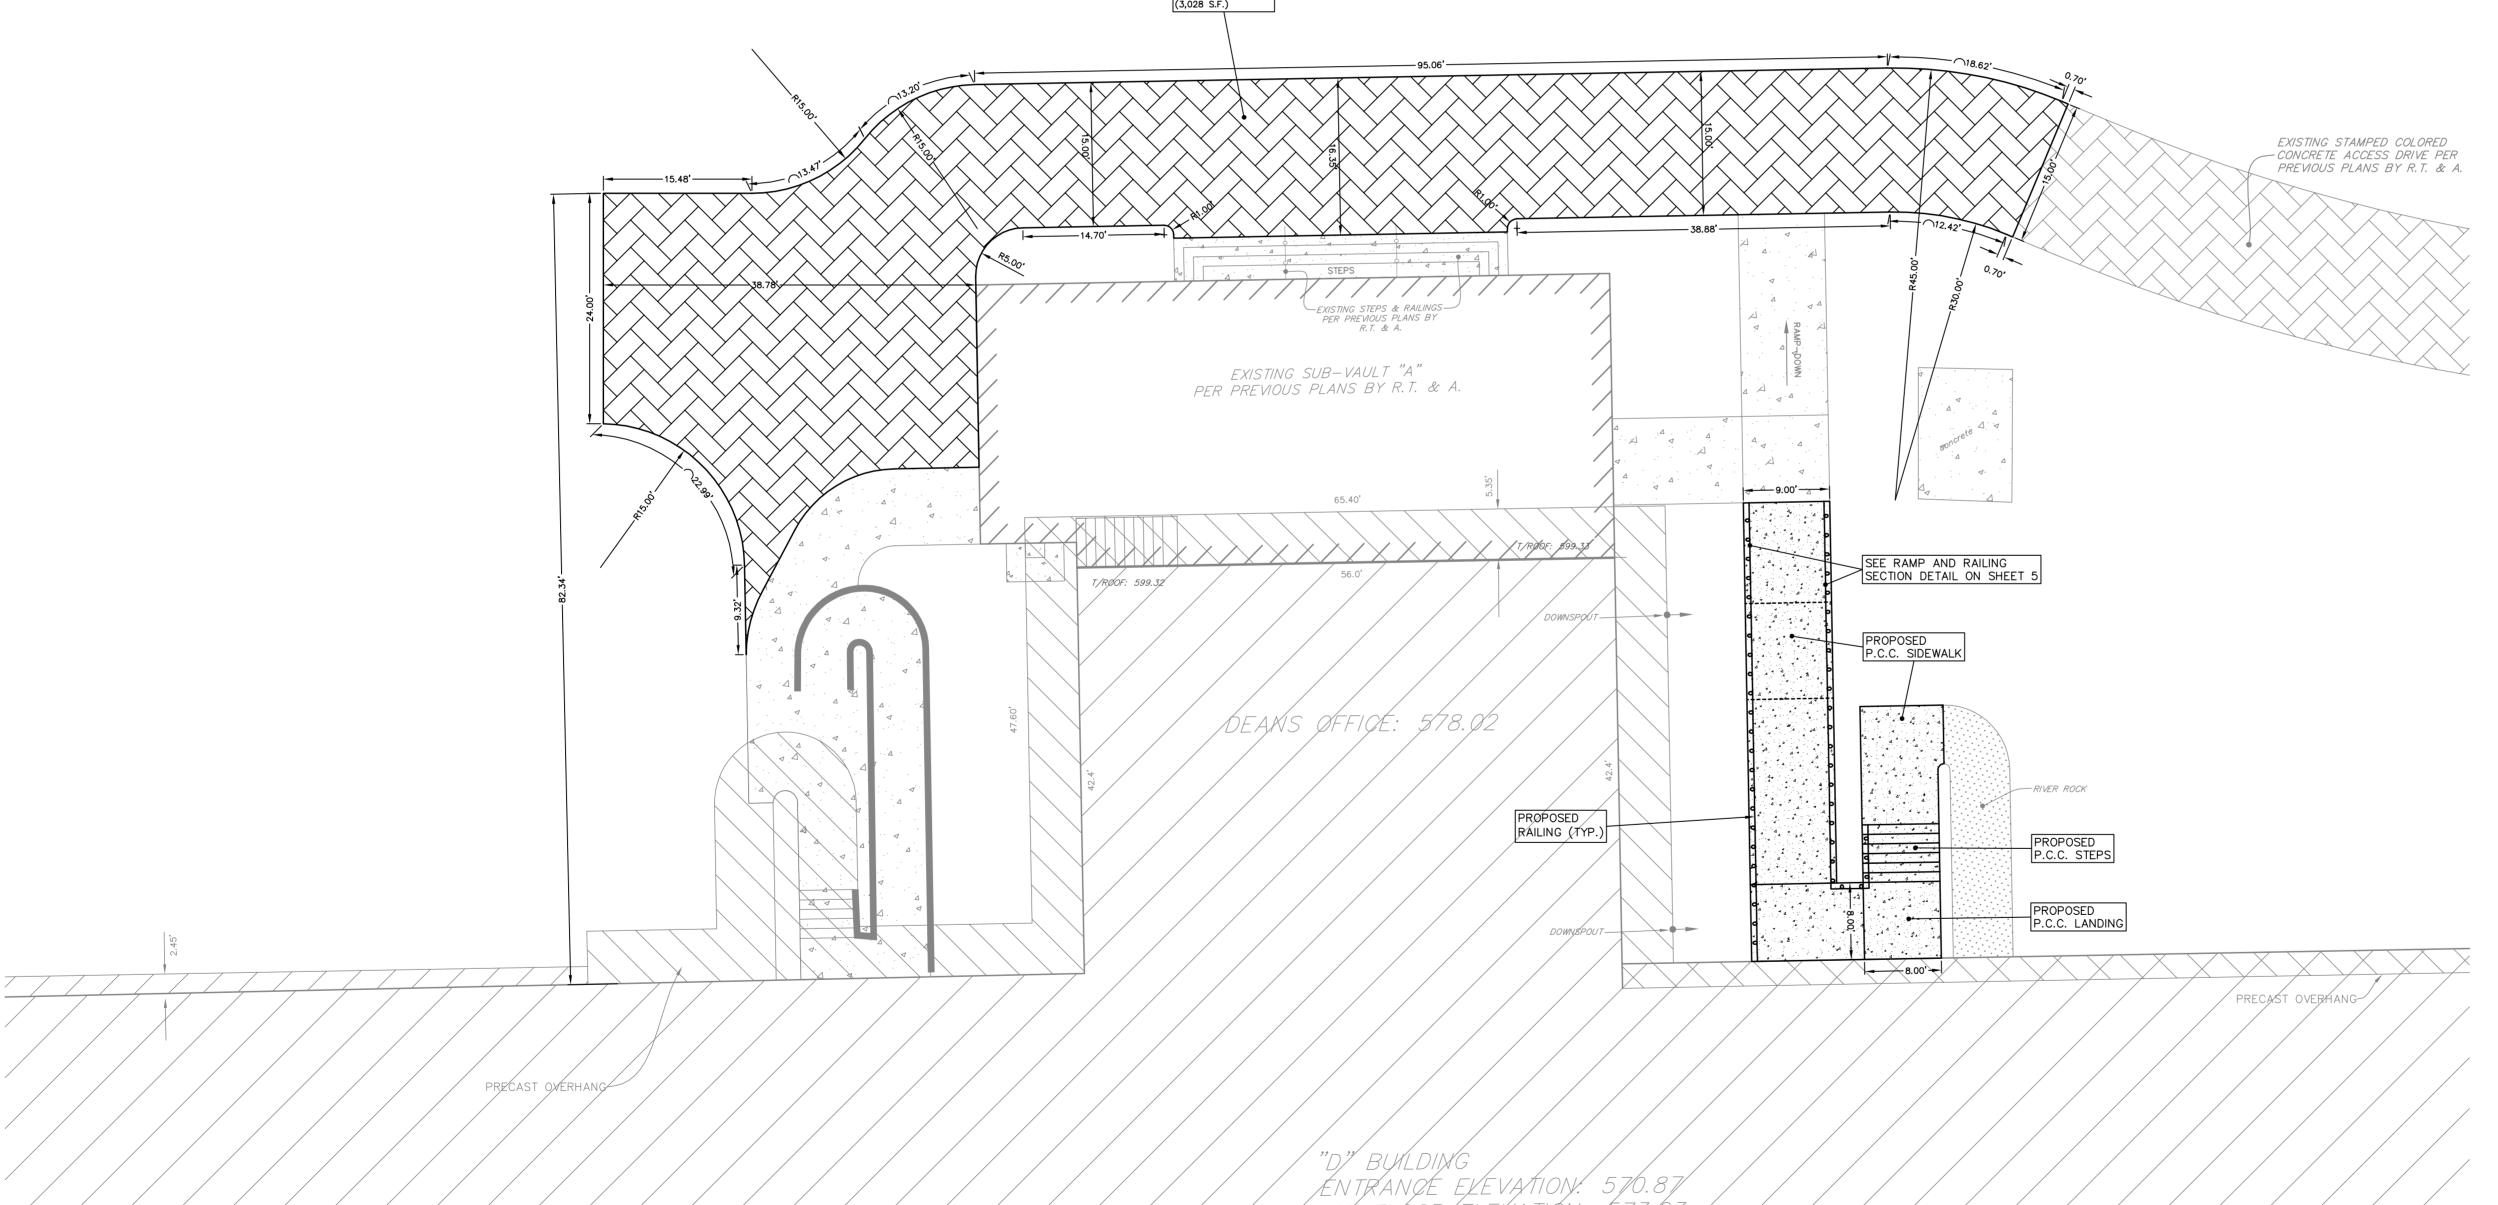

SITE BENCHMARK 1:

HEAD BOLT ON FIRE HYDRANT THAT ARROW
POINTS TO, LOCATED APPROXIMATELY 740' SOUTH
OF MAIN CAMPUS EXIT ROAD ONTO HOUBOLT ROAD.

ELEVATION: 607.75 (NAVD 88)

SITE BENCHMARK 2:

HEAD BOLT ON FIRE HYDRANT THAT ARROW
POINTS TO, LOCATED APPROXIMATELY 305' SOUTH
OF MAIN CAMPUS EXIT ROAD ONTO HOUBOLT ROAD.

ELEVATION: 601.09 (NAVD 88)

FIELD VERIFY BENCHMARK WITH BENCHMARK LIST.

REVISIONS DOCUMENTATION: BY No. DATE DESCRIPTION No. DATE DESCRIPTION PROJECT No.: 20121330.00 REVISED PER CLIENT REVIEW R.P. 1 |11-18-2013 2 | 12-09-2013 | REVISED PER CLIENT REVIEW DATE: 10-08-2013 3 2-05-2014 REVISED PER JOLIET JUNIOR COLLEGE FIELD BOOK: DRAWN BY: R.P. CHECKED BY: J.H.

RT-

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PROJECT TITLE:

JOLIET JUNIOR COLLEGE

MAIN CAMPUS - REAR ACCESS DRIVE

1215 HOUBOLT ROAD

JOLIET, ILLINOIS 60431


DRAWING TITLE:

PROPOSED GEOMETRY PLAN

DRAWING No.
312-1330-C2

SCALE:
AS NOTED

ENGINEERING DEPARTMENT SHEET 4 OF 5

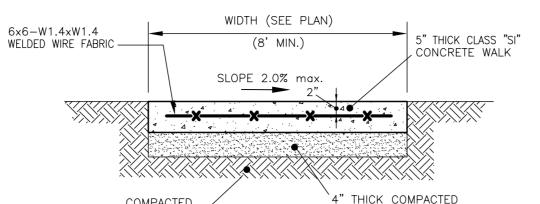



AGGREGATE SUBBASE 1. SURFACE TO BE A LIGHT BROOM FINISH AT RIGHT ANGLES TO THE

- 2. ASPHALTIC FELT EXPANSION JOINTS SHALL BE PROVIDED 24'-0" ON CENTER. WITH 1/2" DEEP CONTROL (FALSE) JOINTS 8'-0" ON CENTER.
- 3. CONTROL JOINTS SHALL BE TROWELED.

EDGES OF THE SIDEWALK.

4. ALL SIDEWALKS TO HAVE 6x6xW1.4xW1.4 WELDED WIRE FABRIC. TYPICAL P.C.C. SIDEWALK NOT TO SCALE

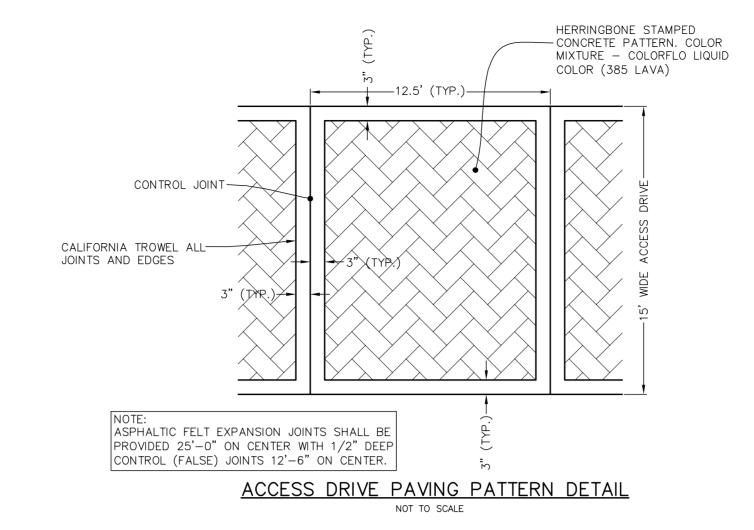


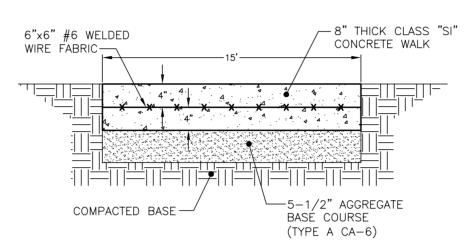

ACCESS DRIVE SECTION DETAIL NOT TO SCALE

EROSION CONTROL NOTES

- EROSION CONTROL TO BE APPLIED PER THE ILLINOIS PROCEDURES FOR URBAN SOIL EROSION AND SEDIMENTATION CONTROL MANUAL, LATEST EDITION.
- 2. THE TEMPORARY EROSION CONTROL SYSTEMS INSTALLED BY THE CONTRACTOR SHALL BE PROPERLY MAINTAINED AS DIRECTED BY THE VILLAGE TO CONTROL SILTATION AT ALL TIMES DURING THE LIFE OF THE CONTRACT.
- ALL STORM SEWER STRUCTURES WITH OPEN GRATES SHALL BE PROTECTED BY INSTALLING FILTER BASKETS FOR THE DURATION OF THE CONSTRUCTION, UNTIL FINAL PERMANENT STABILIZATION IS ACHIEVED.
- 4. DISTURBED AREAS SHALL BE STABILIZED WITH TEMPORARY OR PERMANENT MEASURES WITHIN (7) SEVEN CALENDAR DAYS FOLLOWING THE END OF ACTIVE DISTURBANCE, RE-DISTURBANCE, CONSISTENT WITH THE FOLLOWING CRITERIA. APPROPRIATE TEMPORARY OR PERMANENT STABILIZATION MEASURES SHALL INCLUDE SEEDING, MULCHING, SODDING AND / OR NON-VEGETATIVE MEASURES.
- 5. ALL EROSION CONTROL ITEMS REMAIN IN PLACE AND BE MAINTAINED UNTIL DEEMED UNNECESSARY BY THE OWNER / DEVELOPER AND THE VILLAGE AT WHICH TIME THE EROSION CONTROL ITEMS SHALL BE COMPLETELY REMOVED FROM THE
- ALL DISTURBED AREAS NOT SPECIFICALLY IDENTIFIED FOR LANDSCAPING IMPROVEMENTS OR IMPERVIOUS SURFACE TREATMENTS SUCH AS PAVEMENTS, DRIVES, PATIOS, STOOPS, SIDEWALKS OR WALKWAYS SHALL BE FINISHED WITH A MINIMUM OF 6" OF TOPSOIL AND RESTORED IN ACCORDANCE WITH THE ILLINOIS DEPARTMENT OF TRANSPORTATION'S "STANDARD SPECIFICATIONS FOR ROAD AND BRIDGE CONSTRUCTION" ADOPTED JANUARY 1, 2002 AS FOLLOWS: CLASS 2 SEED PER SECTION 250.
- · FERTILIZED NUTRIENTS IN THE RATIO OF 1:1:1 OF NITROGEN, PHOSPHOROUS AND POTASSIUM EACH, ALL AT THE RATE OF 60 LBS/ACRE IN ACCORDANCE WITH SECTION 250.
- EROSION CONTROL BLANKET: EXCELSIOR GREEN BLANKET (I.D.O.T. SEC. 251.04)
 CONTRACTOR SHALL MAINTAIN RESTORED AREA AS NEEDED UNTIL GERMINATION IS COMPLETED AND THE OWNER, OR LOCAL AGENCY HAVING JURISDICTION, HAS ACCEPTED THE WORK.
- 7. FOR EACH PHASE OF WORK, THE CONTRACTOR RESPONSIBLE FOR THAT WORK IS TO PROVIDE QUALIFIED PERSONNEL
- WHO SHALL INSPECT: DISTURBED AREAS OF THE CONSTRUCTION SITE WHICH HAVE NOT BEEN STABILIZED WITH IMPERVIOUS MATERIALS OR
- VEGETATIVE GROUND COVER. • STRUCTURAL CONTROL MEASURES (I.E. SILT FENCE, GRATE FABRIC, ETC.).
- OFF SITE ROADS AND ON SITE PAVEMENTS WHICH THE CONTRACTOR'S VEHICLES AND OR EQUIPMENT OPERATE.
- SUCH INSPECTIONS SHALL BE CONDUCTED AT LEAST ONCE EVERY SEVEN (7) CALENDAR DAYS AND WITHIN 24 HOURS OF THE END OF A STORM EVENT THAT HAS 0.5 INCHES OR MORE OF PRECIPITATION.
- ALL INSPECTIONS SHALL BE IN CONFORMANCE WITH THE STORM WATER POLLUTION PREVENTION PLAN INSPECTION
- ANY STOCKPILE OF TOPSOIL MAINTAINED ON SITE SHALL BE STABILIZED WITH A VEGETATION ACCORDING TO NOTE 4 ABOVE. STOCKPILE SHALL BE SURROUNDED WITH SILT FENCE.

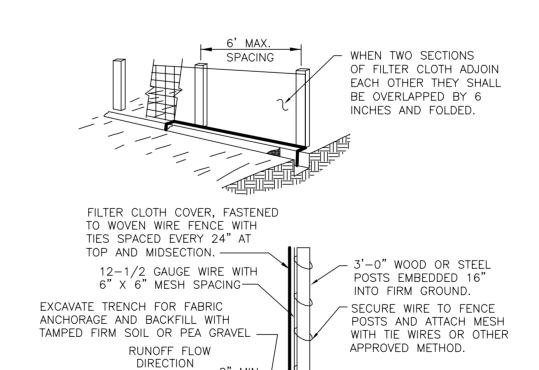


NOTES FOR SILT FENCE

- 1. MAINTENANCE SHALL BE PERFORMED AS NEEDED AND MATERIAL SHALL BE REMOVED WHEN BULGES DEVELOP IN THE SILT FENCE.
- 2. FILTER CLOTH SHALL BE FILTER X, MIRAFI 100X, STABILINKA T140N, OR EQUAL.
- 3. PREFABRICATED UNIT SHALL BE GEOFAB, ENVIROFENCE, OR EQUAL.

SILT FENCE INSTALLATION

NOT TO SCALE


____ __ _8" MIN

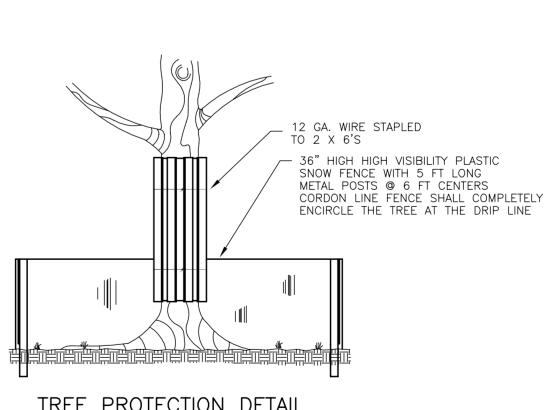

SITE CONSTRUCTION GENERAL NOTES

- 1. CONTRACTOR SHALL VISIT THE SITE PRIOR TO BIDDING TO FAMILIARIZE THEMSELVES WITH THE PROJECT. ALL QUANTITIES NOTED ON THE PLANS ARE TO BE CONSIDERED APPROXIMATE. CONTRACTOR SHALL ACCOUNT FOR ALL IMPROVEMENTS AND VERIFY QUANTITIES AND INCLUDE THEM IN THE BID.
- 2. ALL NEW CONSTRUCTION SHALL BE DONE IN ACCORDANCE WITH "STANDARD SPECIFICATIONS FOR WATER AND SEWER MAIN CONSTRUCTION IN ILLINOIS" LATEST EDITION; AND "STANDARD SPECIFICATIONS FOR ROAD AND BRIDGE CONSTRUCTION" - ILLINOIS DEPARTMENT OF TRANSPORTATION, LATEST EDITION.
- 3. THE OWNER AND/OR CONTRACTOR ARE REQUIRED TO FILE A NOTICE OF INTENT (NOI) WITH THE ILLINOIS ENVIRONMENTAL PROTECTION AGENCY (IEPA) RELATIVE TO STORM WATER DISCHARGE QUALITY, AND OBTAIN A GENERAL PERMIT ILR-10 OR OTHER NATIONAL POLLUTANT ELIMINATION SYSTEM (NPDES) PERMIT AS MAY BE REQUIRED PRIOR TO ANY SITE CONSTRUCTION.
- 4. ALL WORK SHALL BE SUBJECT TO INSPECTION BY CONSTRUCTION MANAGER.
- 5. UNLESS NOTED OTHERWISE, ANY UNDERGROUND SEWER OR DRAIN TILE SHALL REMAIN IN OPERATION, AND IF DAMAGED SHALL BE REPAIRED TO EXISTING OR BETTER CONDITION. THE OWNER OF THE TILE AND THE CONSTRUCTION MANAGER SHALL BE NOTIFIED BEFORE TRENCH IS BACKFILLED.
- 6. CONTRACTOR SHALL FIELD VERIFY EXISTING CONDITIONS AND NOTIFY THE OWNER, CONSTRUCTION MANAGER AND ENGINEER IF THERE IS ANY DISCREPANCY BETWEEN THE PLANS AND EXISTING CONDITIONS PRIOR TO PROCEEDING WITH ANY STAGE OF CONSTRUCTION OF PROPOSED IMPROVEMENTS.
- 7. GRANULAR BACKFILL TO BE CRUSHED LIMESTONE CA-6.
- 8. EROSION CONTROL TO BE APPLIED PER THE ILLINOIS PROCEDURES FOR URBAN SOIL EROSION AND SEDIMENTATION CONTROL MANUAL, LATEST EDITION.
- 9. IT SHALL BE THE CONTRACTOR'S RESPONSIBILITY TO COMPLETELY REMOVE AND PROPERLY DISPOSE OF EXISTING STRUCTURES. DEBRIS. WASTES AND VEGETATION FROM THE SITE AS NOTED ON THE PLAN OR AS MAY BE REQUIRED TO PROPERLY COMPLETE HIS WORK. ALL DEBRIS AND SURPLUS MATERIALS REMOVED FROM THE SITE SHALL BE PROPERLY DISPOSED OF BY THE CONTRACTOR. NO ON-SITE BURNING OR BURIAL SHALL BE ALLOWED.
 - THE CONTRACTOR SHALL MAINTAIN THE SITE IN A CLEAN AND ORDERLY MANNER AT ALL TIMES. DEBRIS AND SURPLUS MATERIAL CLEAN UP AND REMOVAL SHALL PROCEED AS THE WORK

CallBefore You Dig CONTACT J.U.L.I.E. at 811 or 800-892-0123 48 Hours (2 Working Days) BEFORE YOU DIG. Include the following: County, City/Township, Section & ¼ Section No.

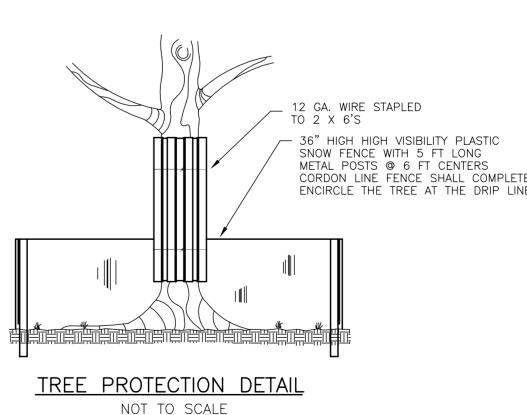

	R E V I S I O N S						
No.	DATE	DESCRIPTION	BY	No.	DATE	DESCRIPTION	BY
1	11-18-2013	REVISED PER CLIENT REVIEW	R.P.				
2	12-09-2013	REVISED PER CLIENT REVIEW	R.P.				
3	2-05-2014	REVISED PER JOLIET JUNIOR COLLEGE	R.P.				

DOCUMENTATION: PROJECT No.: 20121330.00 DATE: 10-08-2013 FIELD BOOK: DRAWN BY: R.P. CHECKED BY: J.H.



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PROJECT TITLE:


JOLIET JUNIOR COLLEGE **MAIN CAMPUS - REAR ACCESS DRIVE 1215 HOUBOLT ROAD JOLIET, ILLINOIS 60431**

DRAWING TITLE:

GENERAL NOTES AND CONSTRUCTION DETAILS DRAWING No. 312-1330-C2 SCALE:

AS NOTED

ENGINEERING DEPARTMENT SHEET 5 OF 5

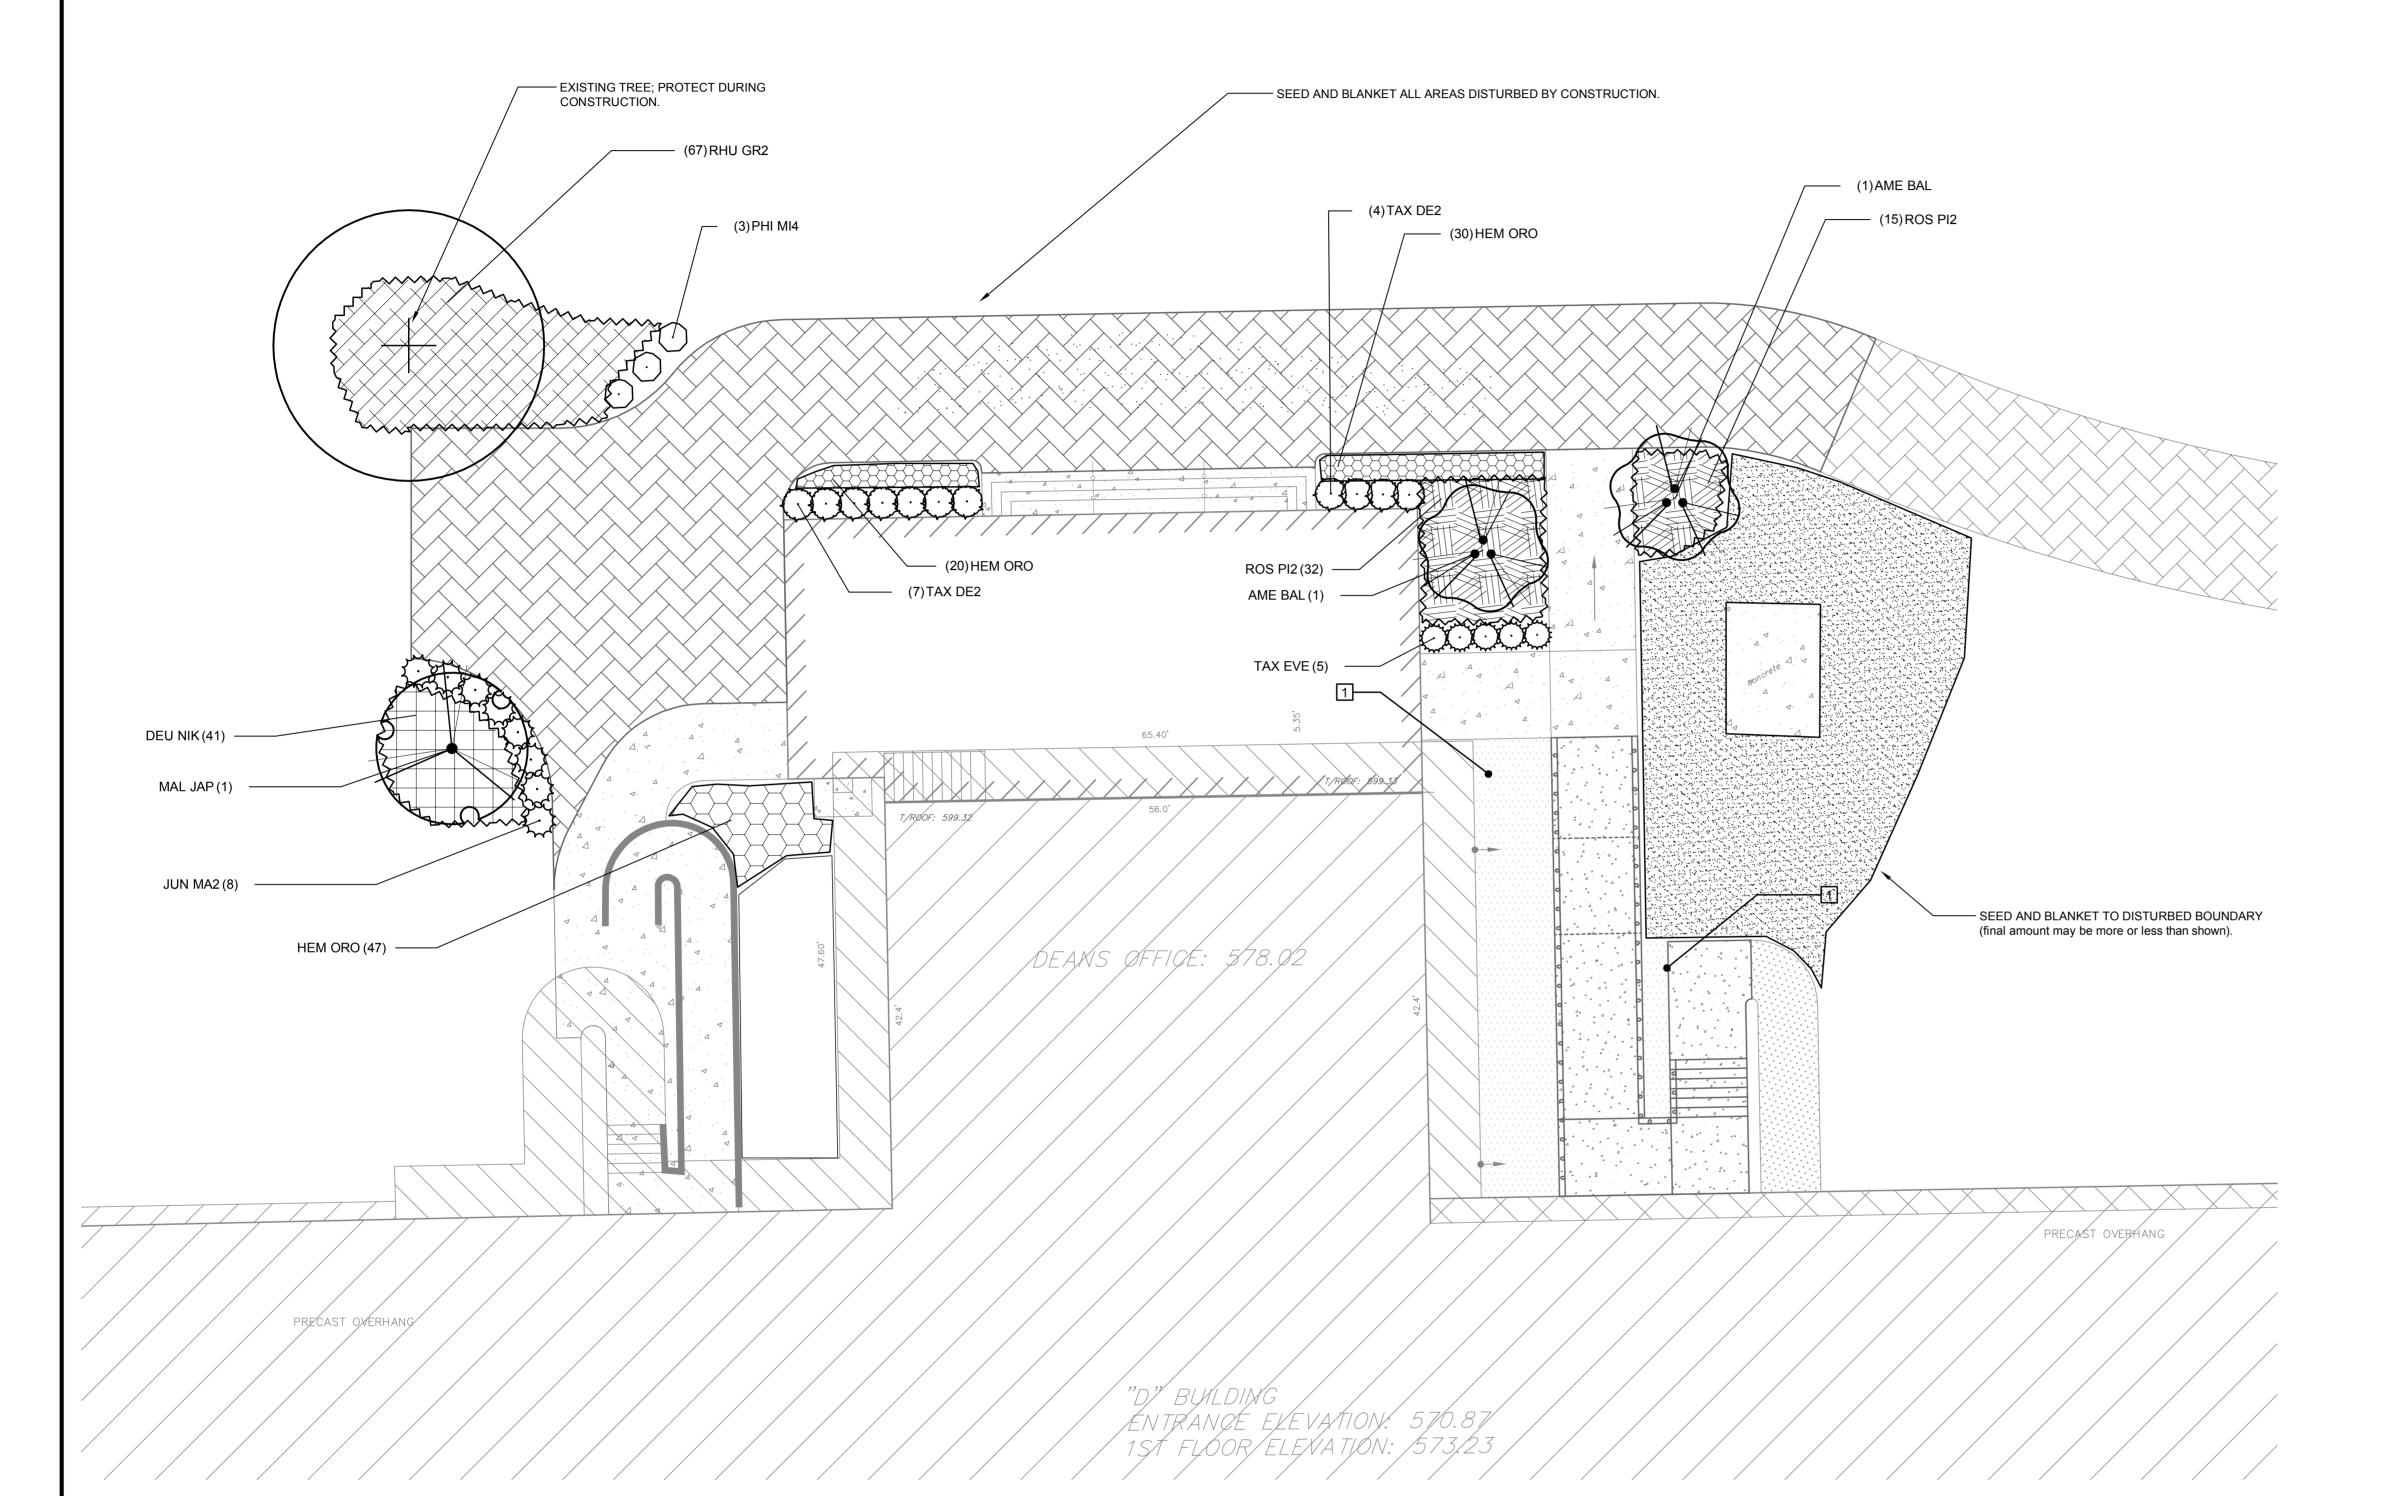

PLANT SCHEDULE

FLOWERING TREES AME BAL	QTY 2	BOTANICAL NAME / COMMON NAME Amelanchier x grandiflora `Ballerina` / Ballerina Serviceberry	SIZE 6` Ht, BB	
MAL JAP	1	Multi-Stem Malus floribunda / Japanese Flowering Crabapple	6` Ht, BB	
SHRUBS PHI MI4	QTY 3	BOTANICAL NAME / COMMON NAME Philadelphus x virginalis `Miniature Snowflake` / Miniature Snowflake Mockorange	SIZE 2.5` Ht	
EVERGREEN SHRUBS JUN MA2 TAX DE2 TAX EVE	S QTY 8 11 5	BOTANICAL NAME / COMMON NAME Juniperus chinensis `Maneyi` / Maney Juniper Taxus media `Densiformis` / Dense Yew Taxus x media `Everlow` / Yew	SIZE 18-24" Sprd, BB 24-30" Sprd, BB 18-24" Sprd, BB	
SHRUB AREAS DEU NIK RHU GR2 ROS PI2	<u>QTY</u> 41 67 47	BOTANICAL NAME / COMMON NAME Deutzia gracilis `Nikko` / Slender Deutzia Rhus aromatica `Gro-Low` / Gro-Low Fragrant Sumac Rosa acicularis `Pink Meidiland` / Pink Shrub Rose Growth Height at 12".	SIZE 3 gal 3 gal 3 gal	<u>SPACING</u> 24" o.c. 30" o.c. 30" o.c.
GRNDCOVER/PEREN HEM ORO	NIALS QTY 97	BOTANICAL NAME / COMMON NAME Hemerocallis hybrid `Stella de Oro` / Stella de Oro Daylily	SIZE 1 gal	SPACING 18" o.c.
SOD/SEED TUR SEE	<u>QTY</u> 1,623 sf	BOTANICAL NAME / COMMON NAME Turf Seed / See Specifications	SIZE seed (sq.ft.)	SPACING

REFERENCE NOTES SCHEDULE

SYMBOL DESCRIPTION QTY DETAIL

River Rock Mulch To Match Existing Rock Mulch, place minimum 3" depth 437 sf

| No. | DATE | DESCRIPTION | BY | No. | DATE | DESCRIPTION | BY | PROJECT No.: | 20121330 | DATE: | 12-10-2013 | TILL | DESCRIPTION | DESCRIPTION | DATE: | 12-10-2013 | TILL | DESCRIPTION | DATE: | 12-10-2013 | DATE: | TILL | DESCRIPTION | DATE: | DE

Ruettiger, Tonelli & Associates, Inc.

Surveyors • Engineers • Planners • Landscape Architects • G.I.S. Consultants

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PROJECT TITLE:

JOLIET JUNIOR COLLEGE

MAIN CAMPUS - REAR ACCESS DRIVE

1215 HOUBOLT ROAD

JOLIET, ILLINOIS 60431

LANDSCAPE PLAN

DRAWING TITLE:

DRAWING No.							
312-1330-LS2							
SCALE:							

AS NOTED

LANDSCAPE DEPARTMENT

SHEET L1 OF L2

A. GENERAL

- 1. CONTRACTOR SHALL VERIFY LOCATIONS OF ALL UNDERGROUND UTILITIES PRIOR TO DIGGING AND VERIFY SITE CONDITIONS AND INFORMATION ON DRAWINGS. PROMPTLY REPORT ANY CONCEALED CONDITIONS, DISCREPANCIES, OR DEVIATIONS FROM THE INFORMATION SHOWN IN THE CONTRACT DOCUMENTS. THE OWNER IS NOT RESPONSIBLE FOR UNAUTHORIZED CHANGES OR EXTRA WORK REQUIRED TO CORRECT UNREPORTED DISCREPANCIES.
- 2. CONTRACTOR SHALL BE RESPONSIBLE FOR DAILY CLEANUP OF ALL TRASH AND DEBRIS FROM HIS WORK.
- 3. CONTRACTOR SHALL SECURE AND PAY FOR PERMITS, FEES AND INSPECTIONS NECESSARY FOR THE PROPER EXECUTION OF THE WORK. CONTRACTOR SHALL COMPLY WITH APPLICABLE LOCAL CODES AND LANDSCAPE DESIGN STANDARDS IN THE PERFORMANCE OF THE WORK.
- 4. LANDSCAPE CONTRACTOR SHALL SUBMIT CERTIFICATES OF INSURANCE FOR WORKMAN'S COMPENSATION AND GENERAL LIABILITY.
- 5. MINOR ADJUSTMENTS TO PLANT LOCATIONS MAY BE NECESSARY DUE TO FIELD CONDITIONS, FINAL GRADING, AND UTILITY LOCATIONS. THE CONTRACTOR SHALL NOTIFY THE OWNER IF MAJOR ADJUSTMENTS ARE REQUIRED.
- 6. NO SUBSTITUTIONS IN TYPE OR SIZE WILL BE ACCEPTED WITHOUT WRITTEN APPROVAL FROM OWNER'S REPRESENTATIVE. PLANTS NOT CONFORMING TO PLANT LIST SHALL NOT BE ACCEPTED WITHOUT WRITTEN APPROVAL AND MAY BE REPLACED AT THE CONTRACTOR'S EXPENSE.
- 7. ALL LANDSCAPE WORK SHALL BE IN ACCORDANCE TO STANDARDS ESTABLISHED FOR LANDSCAPE CONSTRUCTION AND PLANTING IN THE ILLINOIS STANDARDIZED LANDSCAPE SPECIFICATIONS (ASLA), AMERICAN ASSOCIATION OF NURSERYMAN, AND LOCAL LANDSCAPE ORDINANCES.

B. SITE PREPARATION

- 1. FINE GRADE LANDSCAPE AREAS TO SMOOTH, FREE DRAINING, EVEN SURFACE, FREE OF LARGE STONES, DEBRIS, AND DEPRESSIONS.
- 2. SITE FOR SEEDING TO HAVE A MINIMUM OF 6" OF TOPSOIL APPLIED BEFORE SEEDING.
- 3. AREAS OF WEED GROWTH SHALL BE HERBICIDED AND REMOVED OR TILLED, RAKED AND REMOVED PRIOR TO SEEDING.
- 4. NO SEEDING SHALL START UNTIL FINAL GRADES HAVE BEEN APPROVED BY THE OWNER. SEEDING DONE WITHOUT GRADE APPROVAL MAY RESULT IN AREAS BEING RESEEDED AT CONTRACTOR'S EXPENSE.
- 5. PLANTING AREAS CREATED WITHIN EXISTING PARKING LOTS SHALL BE EXCAVATED A MINIMUM OF 3 FEET BELOW PAVEMENT SURFACE. EXCAVATED MATERIAL SHALL BE REMOVED AND NOT MIXED WITH PLANTING MIX. PROVIDE UNDERDRAINAGE AS NECESSARY OR AS SHOWN ON PLANS AND DETAILS.

C. PLANTINGS AND TOPSOIL

- 1. PLANTING MIX FOR TREES AND SHRUBS SHALL CONSIST OF 60% ACCEPTABLE, ORGANIC TOPSOIL AND 40% MUSHROOM COMPOST, OR OTHER MEDIUM APPROVED BY OWNER.
- 2. ALL PLANTS SHALL BE NURSERY GROWN WITH SHAPES AND DIMENSIONS IN ACCORDANCE WITH AMERICAN STANDARDS FOR NURSERY STOCK.
- 3. ALL PLANTS SHALL BE TYPICAL OF THEIR SPECIES OR VARIETY AND SHALL HAVE A NORMAL HABIT OF GROWTH. THEY SHALL BE SOUND, HEALTHY AND VIGOROUS, WELL BRANCHED AND DENSELY FOLIATED WHEN IN LEAF, SHALL BE FREE OF DISEASE AND INSECT PESTS, EGGS OR LARVAE, AND SHALL HAVE HEALTHY, WELL-DEVELOPED ROOT SYSTEMS.
- 4. BALLED AND BURLAPPED PLANTS SHALL BE DUG WITH FIRM NATURAL BALLS OF EARTH, OF DIAMETER AND DEPTH TO INCLUDE MOST OF THE FIBROUS ROOTS. CONTAINER GROWN STOCK SHALL HAVE BEEN GROWN IN A CONTAINER LONG ENOUGH FOR THE ROOT SYSTEM TO HAVE DEVELOPED SUFFICIENTLY TO HOLD ITS SOIL TOGETHER FIRM AND WHOLE. NO PLANTS SHALL BE LOOSE IN THE CONTAINER.
- 5. ROOT BALLS OF ALL PLANTS SHALL BE ADEQUATELY PROTECTED AT ALL TIMES FROM SUN AND DRYING WINDS OR FROST. PLANTS WITH BROKEN ROOT BALLS OR EXCESSIVE DAMAGE TO THE CROWN SHALL BE REPLACED PRIOR TO PLANTING. THE TOP 1/3 OF BURLAP SHALL BE PULLED BACK AT PLANTING TIME AND ALL TWINES AROUND TREE TRUNKS SHALL BE CUT AND REMOVED.
- 6. SHRUB, PERENNIAL AND GROUND COVER MASSES SHALL BE PLACED IN PLANTING BEDS PREPARED TO INCLUDE 10-10-10 FERTILIZER TO PLANTING SOIL AT THE RATE OF 1/2 POUND PER CUBIC YARD OF PLANTING SOIL. A PRE-EMERGENCE HERBICIDE SHALL BE APPLIED TO THE PLANTING BED IN ACCORDANCE WITH THE MANUFACTURER'S INSTRUCTIONS. PLANTING BEDS SHALL BE MULCHED WITH GROUND HARDWOOD MULCH, MINIMUM 3" THICK.
- 7. SHRUB BEDS AND TREES SHALL BE MULCHED WITH HARDWOOD MULCH AS NOTED.
- 8. DO NOT LOCATE PLANTS WITHIN 10 FEET OF FIRE HYDRANTS, TRANSFORMERS, OR OTHER ABOVE GROUND UTILITIES UNLESS NOTED OTHERWISE ON THE
- 9. ALL BED LINES AND TREE SAUCERS SHALL REQUIRE A HAND-SPADED EDGE BETWEEN LAWN AND MULCHED AREAS UNLESS NOTED OTHERWISE.
- 10. NO BARE ROOT PLANT MATERIAL ALLOWED, UNLESS APPROVED IN WRITING FROM THE OWNER.

D. FERTILIZER AND AMENDMENTS


- 1. DURING SITE PREPARATION AND PRIOR TO SEEDING, APPLY A GRANULAR, NON-BURNING FERTILIZER OF NOT LESS THAN 50% ORGANIC SLOW RELEASE PRODUCT AT A RATE OF 1.5 LBS. PER 1,000 SQUARE FEET.
- 2. STARTER FERTILIZER SHALL HAVE AN APPROXIMATE ANALYSIS OF 6:24:24 OR SIMILAR APPROVED COMPOSITION.
- 3. APPLY FERTILIZER BY MECHANICAL MEANS THOROUGHLY AND EVENLY DISTRIBUTED WITH SOIL BY DISKING, TO A DEPTH OF 3".
- 4. CONTRACTOR SHALL APPLY A PRE-EMERGENT HERBICIDE TO ALL PLANTING BEDS BEFORE APPLICATION OF MULCH.

E. TURF


- 1. GRASS SEED SHALL BE CLEAN, CERTIFIED SEED FREE OF NOXIOUS WEEDS AND MIXED TO THE APPROPRIATE PROPORTIONS BY WEIGHT ACCORDING TO PERCENT BY SPECIES INDICATED.
- 2. SEED AND SOD CERTIFICATION TAGS SHALL BE PROVIDED TO THE OWNER FOR APPROVAL PRIOR TO INSTALLING.
- 3. TURF SEED MIX SHALL CONSIST OF THE FOLLOWING SPECIES PROPORTIONED BY WEIGHT AS FOLLOWS: 40% KENTUCKY BLUEGRASS (MIN 3 VARIETIES), 25% CREEPING RED FESCUE (DAWSON), 15% TURF-TYPE PERENNIAL RYEGRASS, 20% HARD FESCUE (WARWICK).
- 4. SEED SHALL BE APPLIED AT A RATE OF 5 LBS. PER 1,000 SQUARE FEET, UNLESS NOTED OTHERWISE.
- 5. APPLY SEED WITH A ROTARY OR DROP-TYPE DISTRIBUTOR. INSTALL SEED EVENLY BY SOWING EQUAL QUANTITIES IN TWO DIRECTIONS AT RIGHT ANGLES TO EACH OTHER.
- 6. AFTER SEEDING, RAKE SOIL SURFACE LIGHTLY TO INCORPORATE SEED INTO SURFACE. ROLL WITH LIGHT LAWN ROLLER.
- 7. WITHIN 24 HOURS SEEDED AREAS SHALL BE MULCHED WITH PELLETIZED STRAW MULCH (100 LBS/1,000 SF.), MULCH BLANKETS, OR HYDRO MULCH AT THE RATE OF 1,500 LBS/ACRE. IF STRAW MULCH IS USED, IT SHALL BE SPREAD UNIFORMLY AT 2.5 TONS PER ACRE, AND CRIMPED INTO SOIL. ON SLOPES OF 5:1 OR STEEPER, LANDSCAPE MULCH BLANKETS SHALL BE USED.
- 8. NATIVE SEED, IF SPECIFIED, SHALL BE INSTALLED WITH A COVER CROP PER SEED VENDOR RECOMMENDATIONS.
- 9. NATIVE SEED AREAS SHALL NOT REQUIRE FERTILIZER.
- 10. SOD SHALL BE A CERTIFIED TURF GRASS CONTAINING A MINIMUM OF THREE VARIETIES OF BLUEGRASS, UNLESS NOTED DIFFERENTLY ON THE PLANS AND CUT AT A UNIFORM THICKNESS OF 3/4". INSTALL SOD WITHIN 48 HOURS OF CUTTING FROM NURSERY. SOD SHALL BE MINERAL BASE ONLY. SOD SHALL BE ROLLED AND STAKED ON SLOPES.
- 11. CONTRACTOR SHALL SUBMIT SOD GROWER'S CERTIFICATION OF GRASS SPECIES AND IDENTIFY LOCATION.

F. MAINTENANCE - WARRANTY

- 1. CONTRACTOR SHALL WARRANTY PLANTED MATERIAL (TREES, SHRUBS) FOR ONE FULL YEAR FROM DATE OF FINAL ACCEPTANCE AT 100% OF THE INSTALLED PRICE.
- 2. LAWN AREAS, PERENNIALS, AND GROUNDCOVERS SHALL BE UNCONDITIONALLY WARRANTED FOR A PERIOD OF 90 DAYS FROM DATE OF FINAL ACCEPTANCE. PLANT MATERIAL INSTALLED IN THE FALL (SEPTEMBER OR LATER) SHALL HAVE WARRANTY POSTPONED TO SPRING SEASON.
- 3. LANDSCAPE AREAS SHALL BE WATERED A MINIMUM OF TWICE A WEEK DURING ESTABLISHMENT PERIOD AND WEEDED AS NECESSARY TO MAINTAIN A NEAT
- 4. BARE AREAS MORE THAN ONE SQUARE FOOT, SINGULARLY OR IN AGGREGATE, PER ANY 50 SQUARE FEET SHALL BE REPLACED.
- 5. ANY PLANT MATERIAL FOUND TO BE DEFECTIVE SHALL BE REMOVED AND REPLACED WITHIN 30 DAYS OF NOTIFICATION OR IN GROWTH SEASON DETERMINED
- 6. RE-SET SETTLED PLANTS TO PROPER GRADE AND POSITION, TIGHTEN AND REPAIR GUY WIRES AND STAKES, RESTORE PLANTING SAUCERS AND REMOVE DEAD MATERIAL AS NECESSARY.
- 7. LAWN ESTABLISHMENT PERIOD WILL BE IN EFFECT ONCE THE LAWN HAS BEEN MOWED THREE TIMES.

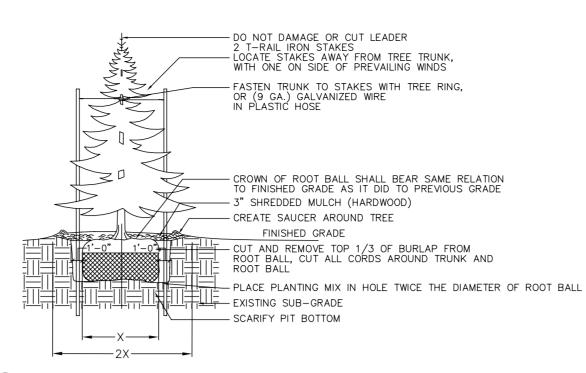


CONIFEROUS TREE DETAIL SCALE: NOT TO SCALE

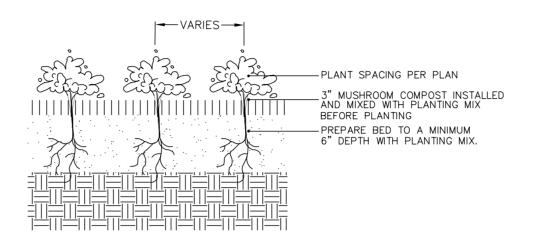


ANNUAL, PERENNIAL & GROUND COVER DETAIL

SCALE: NOT TO SCALE

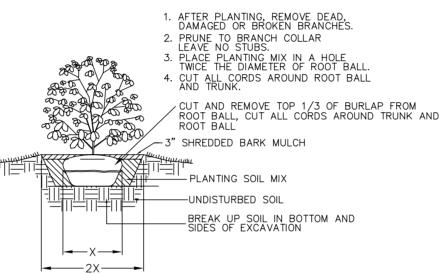

SHRUB PLANTING DETAIL SCALE: NOT TO SCALE

SCALE: NOT TO SCALE

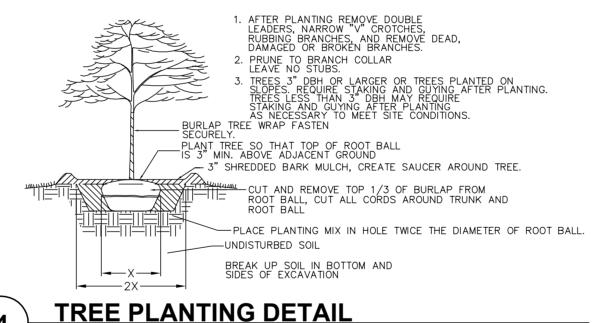

R E V I S I O N S								DOCUMENT	ATION:
No.	DATE	DESCRIPTION	BY	No.	DATE	DESCRIPTION	BY		
								PROJECT No.:	20121330
								DATE:	12-10-2013
								FIELD BOOK:	
								DRAWN BY:	RKS
								CHECKED BY:	RKS



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PROJECT TITLE:

JOLIET JUNIOR COLLEGE MAIN CAMPUS - REAR ACCESS DRIVE 1215 HOUBOLT ROAD **JOLIET, ILLINOIS 60431**

DRAWING TITLE:

LANDSCAPE SPECIFICATIO AND PLANTING DETAILS

DNS	SCALE:

DRAWING No.

AS NOTED LANDSCAPE DEPARTMENT SHEET L2 OF I

312-1330-LS2